

GENERAL NOTES

- **ABINGTON TOWNSHIP** 1176 OLD YORK ROAD ABINGTON, PA 19001 PHONE: 267-536-1000
- TOPOGRAPHIC INFORMATION SHOWN HEREON WAS TAKEN FROM A PLAN ENTITLED "TOPOGRAPHIC SURVEY PLAN, ROYCHESTER PARK, 1819 HARDING AVE," PREPARED BYS 20. CONSTRUCTION STAKING WILL BE PROVIDED BY THE SAS GEOSPATIAL, DATED NOVEMBER 1, 2022.
- THESE PLANS ARE NOT TO BE USED AS SURVEYS. REFER TO REFERENCE SOURCES FOR BOUNDARY AND 21. THE CONTRACTOR SHALL MAINTAIN UPDATED RED-LINED TOPOGRAPHIC INFORMATION (NOTE # 2 ABOVE).
- ALL ELEVATIONS GIVEN ARE ON NAD83.
- NO DEED RESTRICTIONS OR COVENANTS ARE PROPOSED FOR THE SITE
- ALL CROSSWALKS, SIDEWALKS, AND CURB RAMPS WITHIN THE PROJECT LIMITS SHALL CONFORM TO ADA RULES AND 23. REGULATIONS.
- THE CONTRACTOR SHALL CONFINE ALL CONSTRUCTION RIGHT-OF-WAY. ALL DISTURBED AREAS ARE TO BE RESTORED TO EXISTING CONDITIONS OR AS INDICATED IN THE CONTRACT DOCUMENTS.
- THE CONTRACTOR SHALL OBTAIN ALL CONSTRUCTION PERMITS REQUIRED BY LOCAL, COUNTY OR STATE JURISDICTIONS. THE CONTRACTOR SHALL BE RESPONSIBLE FOR APPLICATION, PAYMENT AND APPROVAL OF SAID PERMITS. NO ADDITIONAL PAYMENT SHALL BE MADE BY THE
- THE CONTRACTOR SHALL NOTIFY THE OWNER 72 HOURS PRIOR TO THE START OF WORK. THE CONTRACTOR SHALL COUNTY SOIL CONSERVATION DISTRICT PRIOR TO THE START OF CONSTRUCTION AND AS NECESSARY THROUGH PROJECT COMPLETION.
- 10. THE CONTRACTOR SHALL ABIDE BY ALL MUNICIPAL AND LOCAL JURISDICTIONAL REGULATIONS GOVERNING THE ALLOWABLE HOURS OF WORK FOR THE TYPE OF WORK PERFORMED ON THIS PROJECT.
- 11. ALL ON- SITE, REGULAR (NON-EMERGENCY), WORK WILL BE CONFINED TO MONDAY TO FRIDAY, BETWEEN THE HOURS OF 8:00AM AND 4:30PM.
- 12. OTHER THAN EMERGENCY REPAIR, THE CONTRACTOR SHALL RECEIVE WRITTEN APPROVAL FROM THE OWNER PRIOR TO PROCEEDING WITH ANY ON-SITE WORK DURING "OFF HOURS" (TIME NOT SPECIFIED IN THESE CONTRACT 28. THE CONTRACTOR SHALL IMMEDIATELY NOTIFY THE DESIGN DOCUMENTS).
- 13. UNLESS PRIOR WRITTEN APPROVAL IS OBTAINED FROM THE OWNER, NO ON-SITE, REGULAR WORK WILL BE PERMITTED ON MUNICIPAL HOLIDAYS.
- 14. THE CONTRACTOR SHALL FIELD VERIFY EXISTING CONDITIONS BEFORE BEGINNING CONSTRUCTION.
- 15. THE CONTRACTOR IS RESPONSIBLE FOR CLEANING SITE OF CONSTRUCTION DIRT AND DEBRIS AT CLOSE OF EACH WORK
- 16. PRIOR TO CONSTRUCTION, THE CONTRACTOR, ALONG WITH CONCURRENCE FROM THE OWNER, SHALL DETERMINE HIS/HER LAY-DOWN AND/OR STAGING AREA.
- 17. ANY DAMAGE CAUSED BY THE CONTRACTOR SHALL BE REPLACED WITH LIKE-KIND OR BETTER AT THE CONTRACTOR'S EXPENSE. TREES. BUSHES. SHRUBBERY AND OTHER DAMAGED PLANTINGS TO REMAIN SHALL BE REPLACED WITHIN 72 HOURS OF REMOVAL AND ARE TO BE THOROUGHLY WATERED-IN.
- 18. CONTRACTOR RESPONSIBLE FOR PAVEMENT RESTORATION

(UNIT PAVING, CONCRETE, ASPHALT, STONE, ETC.) FOR ANY DAMAGED, DESTROYED, OR REMOVED LIMITS OF EXISTING PAVEMENT INCLUDING FURNISHING ALL LABOR, MATERIALS AND EQUIPMENT NECESSARY. THE RESTORED CONDITION SHALL BE LIKE NEW.

- 19. PAVED SURFACES, PAVEMENT MARKERS AND MARKINGS SHALL BE PROTECTED FROM DAMAGE BY TRACKED
- CONTRACTOR. TWO COPIES OF STAKING NOTES TO BE PROVIDED TO THE ENGINEER PRIOR TO CONSTRUCTION.
- RECORD DRAWINGS ON SITE FOR INSPECTION BY THE
- 22. MAINTENANCE AND CLEAN-UP OF THE PROJECT IS REQUIRED FOR THE PROJECT LIMITS AND DURATION. REGARDLESS OF THE CONTRACTOR'S SCOPE OF ACTIVITIES WITHIN THE PROJECT LIMITS.
- THE REMOVAL OF ANY ABANDONED UTILITIES REQUIRED TO COMPLETE THE WORK SHALL BE INCIDENTAL AND NO SEPARATE PAYMENT SHALL BE MADE.
- ACTIVITIES TO WITHIN THE LIMIT OF WORK AND/OR THE 24. IT IS THE CONTRACTOR'S RESPONSIBILITY TO STOCKPILE NECESSARY MATERIAL ON-SITE OR AT A SECURED OFF-SITE LOCATION AT NO ADDITIONAL EXPENSE TO THE OWNER.
 - 25. THESE DRAWINGS DO NOT INCLUDE THE NECESSARY COMPONENTS FOR CONSTRUCTION SAFETY. THE CONTRACTOR SHALL BE RESPONSIBLE TO INSURE "ON THE JOB" SAFETY FOR HIS EMPLOYEES. EMPLOYEES OF THE OWNER AND ALL OTHER PERSONS HAVING AUTHORIZED OR UNAUTHORIZED ACCESS TO THE WORK AND THE PUBLIC. CONTRACTOR SHALL PERFORM HIS WORK IN A SAFE MANNER AND IN COMPLIANCE WITH ALL APPLICABLE LOCAL. STATE AND FEDERAL REGULATIONS.
- NOTIFY ALL APPROPRIATE AGENCIES, INCLUDING THE 26. THE LOCATION, TYPE, SIZE, DEPTH, ETC. OF ALL EXISTING UTILITIES ARE APPROXIMATE AND MUST BE VERIFIED IN THE FIELD BY THE CONTRACTOR AND AT HIS OWN EXPENSE PRIOR TO THE START OF CONSTRUCTION. THE CONTRACTOR SHALL NOTIFY ALL UTILITY COMPANIES OPERATING WITHIN THE CONSTRUCTION SITE 3 DAYS PRIOR TO COMMENCEMENT OF ANY EXCAVATION FOR ACCURATE FIELD LOCATIONS. THE CONTRACTOR SHALL IMMEDIATELY NOTIFY THE DESIGN ENGINEER OF ALL DEVIATIONS OF SITE CONDITIONS AND/OR IF DEPARTURES FROM THE APPROVED DESIGN BECOME NECESSARY DUE TO SUCH DEVIATIONS.
 - 27. THE CONTRACTOR SHALL BE RESPONSIBLE FOR ALL LINES, ELEVATIONS, AND MEASUREMENTS, EXERCISING PRECAUTION TO VERIFY ALL DIMENSIONS SHOWN ON DRAWING.
 - ENGINEER SHOULD DEPARTURES FROM THE APPROVED DESIGN BECOME NECESSARY DUE TO CIRCUMSTANCES WHICH ARISE DURING CONSTRUCTION.
 - 29. ITEMS NOT SPECIFIED BUT NECESSARY FOR PROPER CONSTRUCTION SHALL BE FURNISHED AND INSTALLED BY THE CONTRACTOR THE SAME AS IF SPECIFIED.

CONSTRUCTION DOCUMENTS

ABINGTON INCLUSIVE PLAYGROUND

ABINGTON TOWNSHIP, MONTGOMERY COUNTY, PENNSYLVANIA PREPARED BY

ENGINEERING & LAND PLANNING ASSOCIATES, INC.


140 WEST MAIN STREET, HIGH BRIDGE, NEW JERSEY 08829

PLAN INDEX				
SHEET NO.	TITLE			
C-001	COVER			
C-100	EXISTING CONDITIONS PLAN			
C-200	DEMOLITION PLAN			
C-300	SITE & MATERIALS PLAN			
C-310	LAYOUT PLAN			
C-320	CONCRETE JOINT LAYOUT PLAN			
C-330	ADA CIRCULATION PLAN			
C-400	GRADING PLAN			
C-410	DRAINAGE PLAN			
C-420	DRAINAGE AREA PLAN			
C-430	DRAINAGE DETAILS			
C-431	DRAINAGE DETAILS			
C-500	LANDSCAPING PLAN			
C-600	SOIL EROSION & SEDIMENT CONTROL PLAN			
C-610	SESC NOTES			
C-620	SESC DETAILS			
C-700	CONSTRUCTION DETAILS			
C-701	CONSTRUCTION DETAILS			
C-702	CONSTRUCTION DETAILS			
PL-101	PLAY DETAILS			
PL-102	PLAY DETAILS			
PL-103	MAZE WALL DETAILS			
PL-104	MAZE WALL DETAILS			
PL-105	TREEHOUSE DETAILS			
PL-106	TREEHOUSE DETAILS			
PL-107	TREEHOUSE DETAILS			
PL-108	TREEHOUSE DETAILS			

ABINGTON INCLUSIVE PLAYGROUND PROJECT



ABINGTON TOWNSHIP 1176 OLD YORK RD, ABINGTON, PA 19001 (267) 536-1000

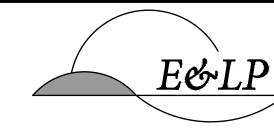

140 WEST MAIN STREET HIGH BRIDGE, NJ 08829 PH. 908-238-0544 FAX. 908-238-9572 A PROFESSIONAL ASSOCIATION



EDWARD D. CONFAIR PROFESSIONAL ENGINEER PENNSYLVANIA PE092932

STUDIO LUDO 1313 S 33RD STREET PHILADELPHIA, PA 19146 (215) 454-6780



SAS GEOSPATIAL, LLC 1432 EASTON ROAD WARRINGTON, PA 18976 (215) 343-5989



ABINGTON INCLUSIVE PARK AND PLAYGROUND


ROYCHESTER PARK TAX MAP ID 30251 013 ABINGTON TOWNSHIP. MONTGOMERY COUNTY, PA


100% CONSTRUCTION DOCUMENTS	09/27/2023
50% CONSTRUCTION DOCUMENTS	08/30/2023
REVISED PER ENGINEER COMMENTS	07/25/2023
100% DESIGN DEVELOPMENT	06/05/23
ISSUANCE	DATE


COVER


OB NO.:	0222032	DRAWING NO.:
SCALE:	AS SHOWN	
DESIGNED:	MMS	C 001
CHECKED:	EDC	C-001
ILENAME: C-0	01 COVER SHEET.DWG	
DATE:	06/02/2023	


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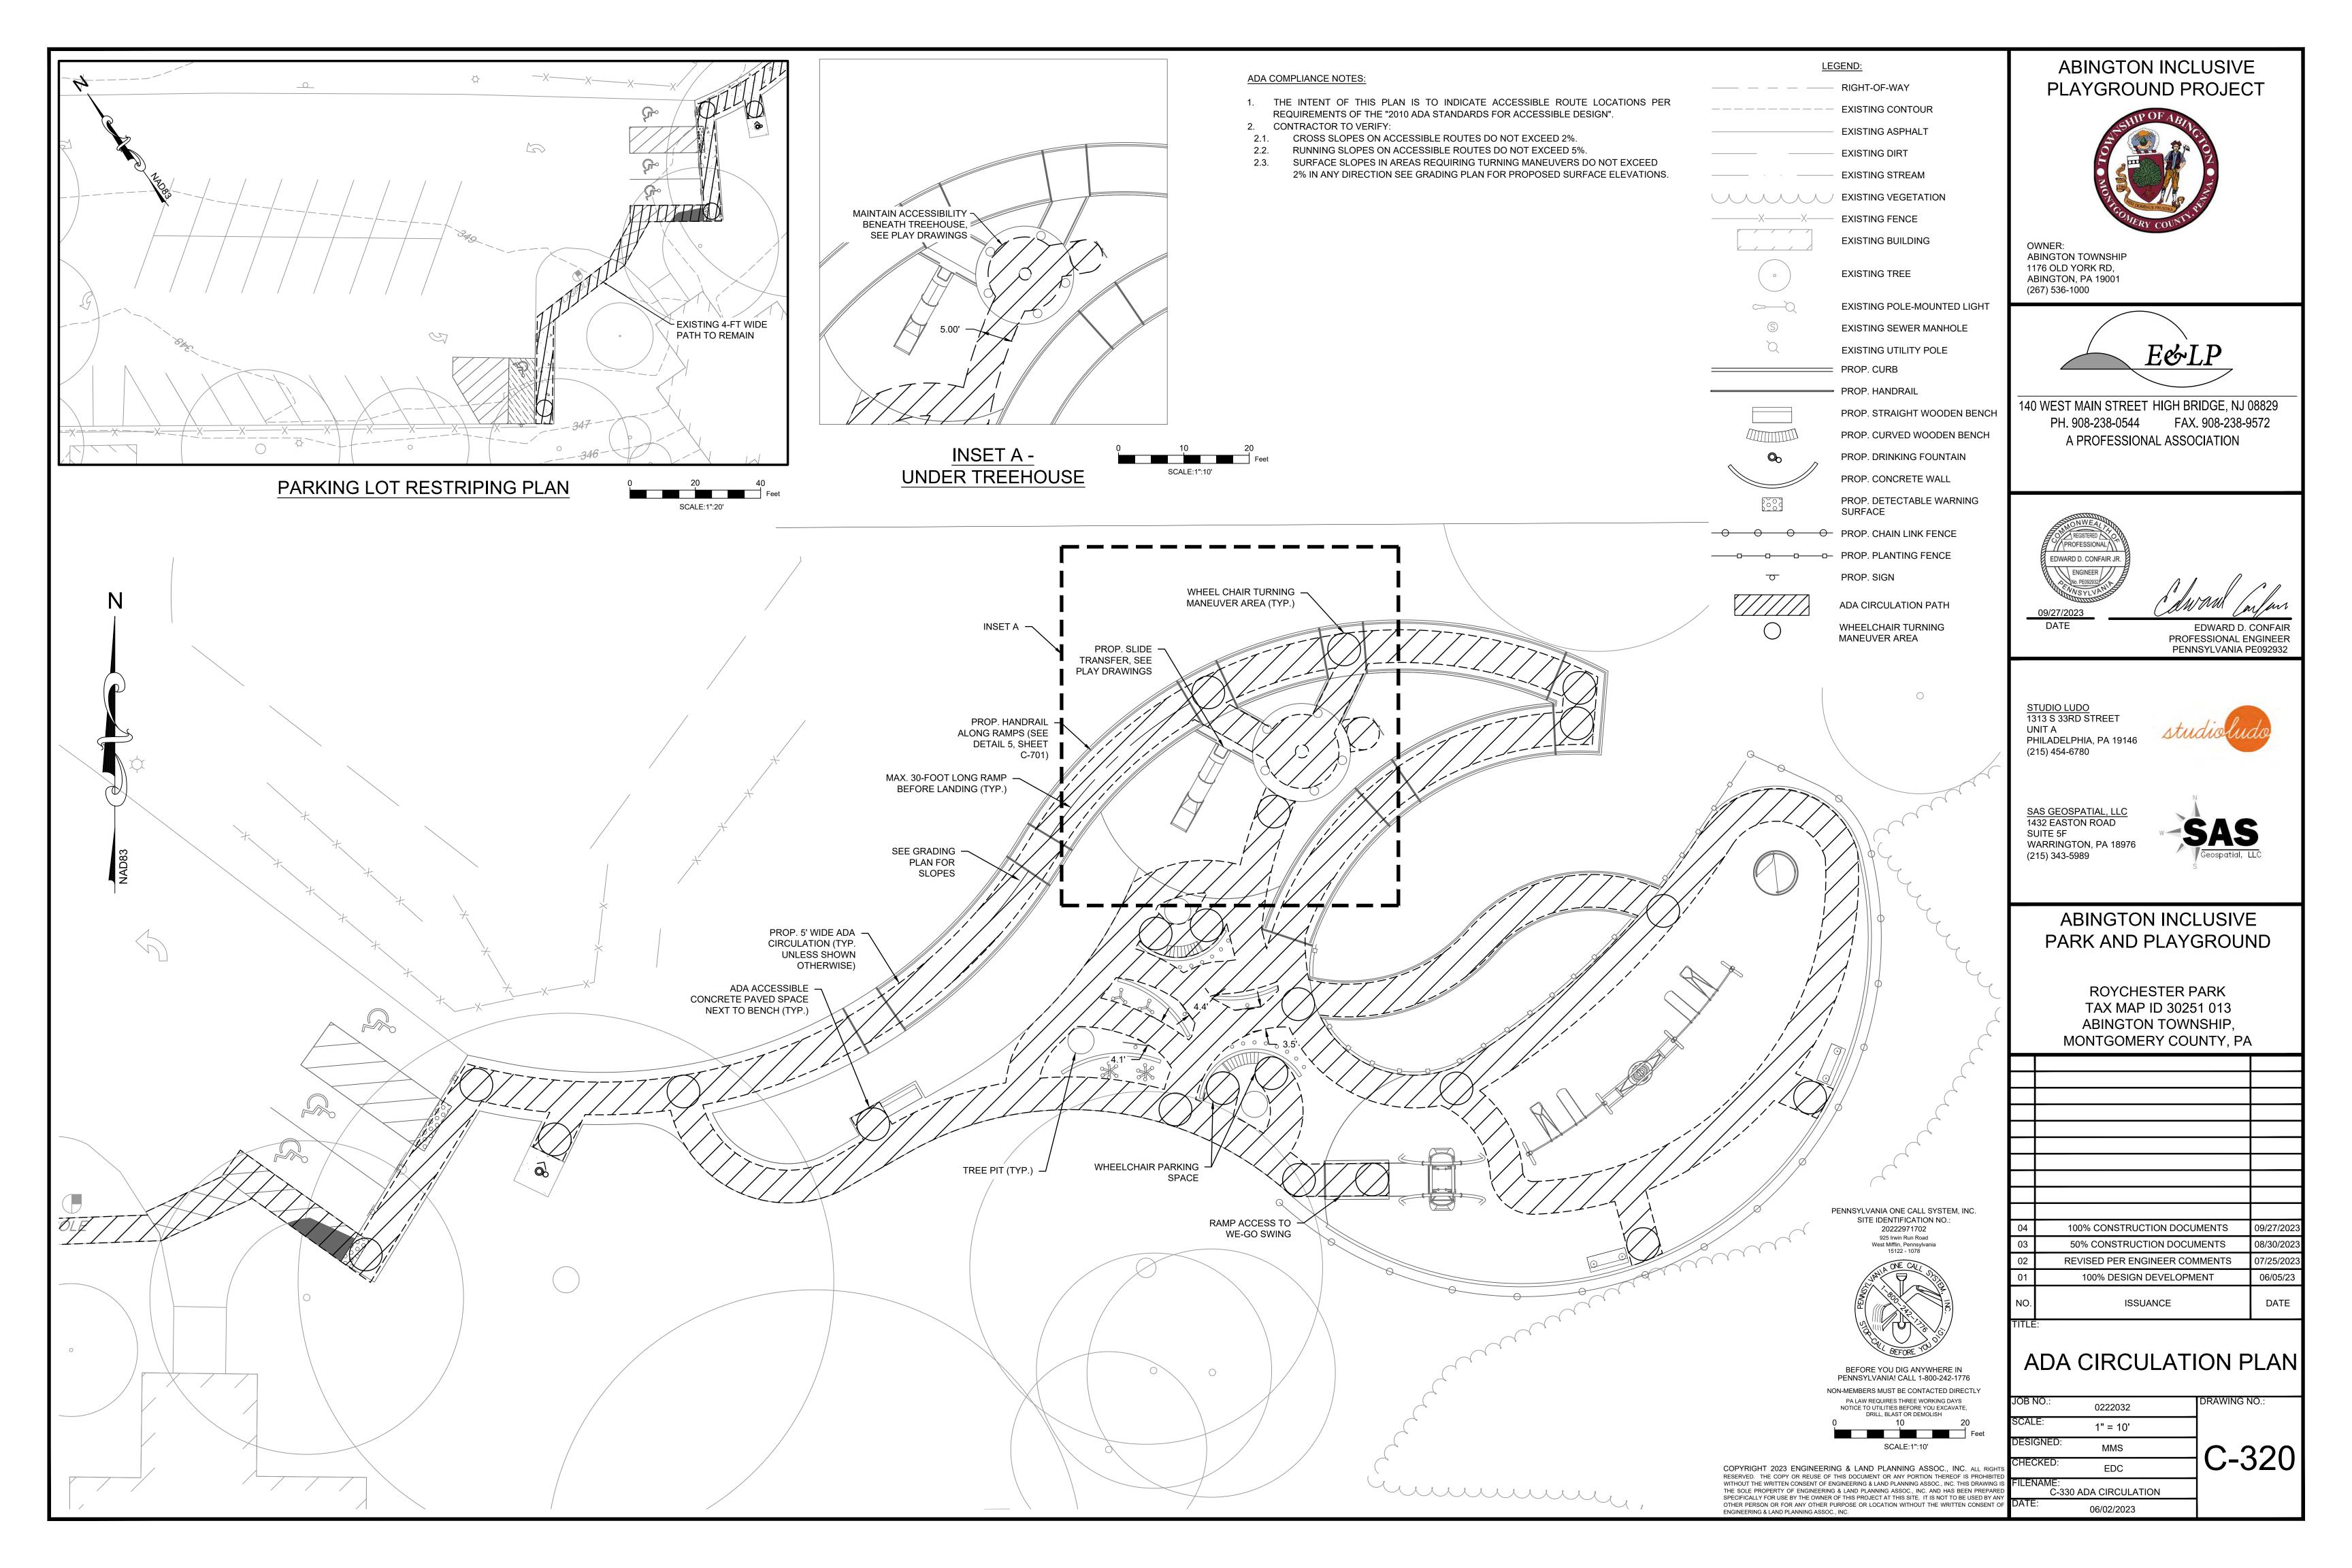


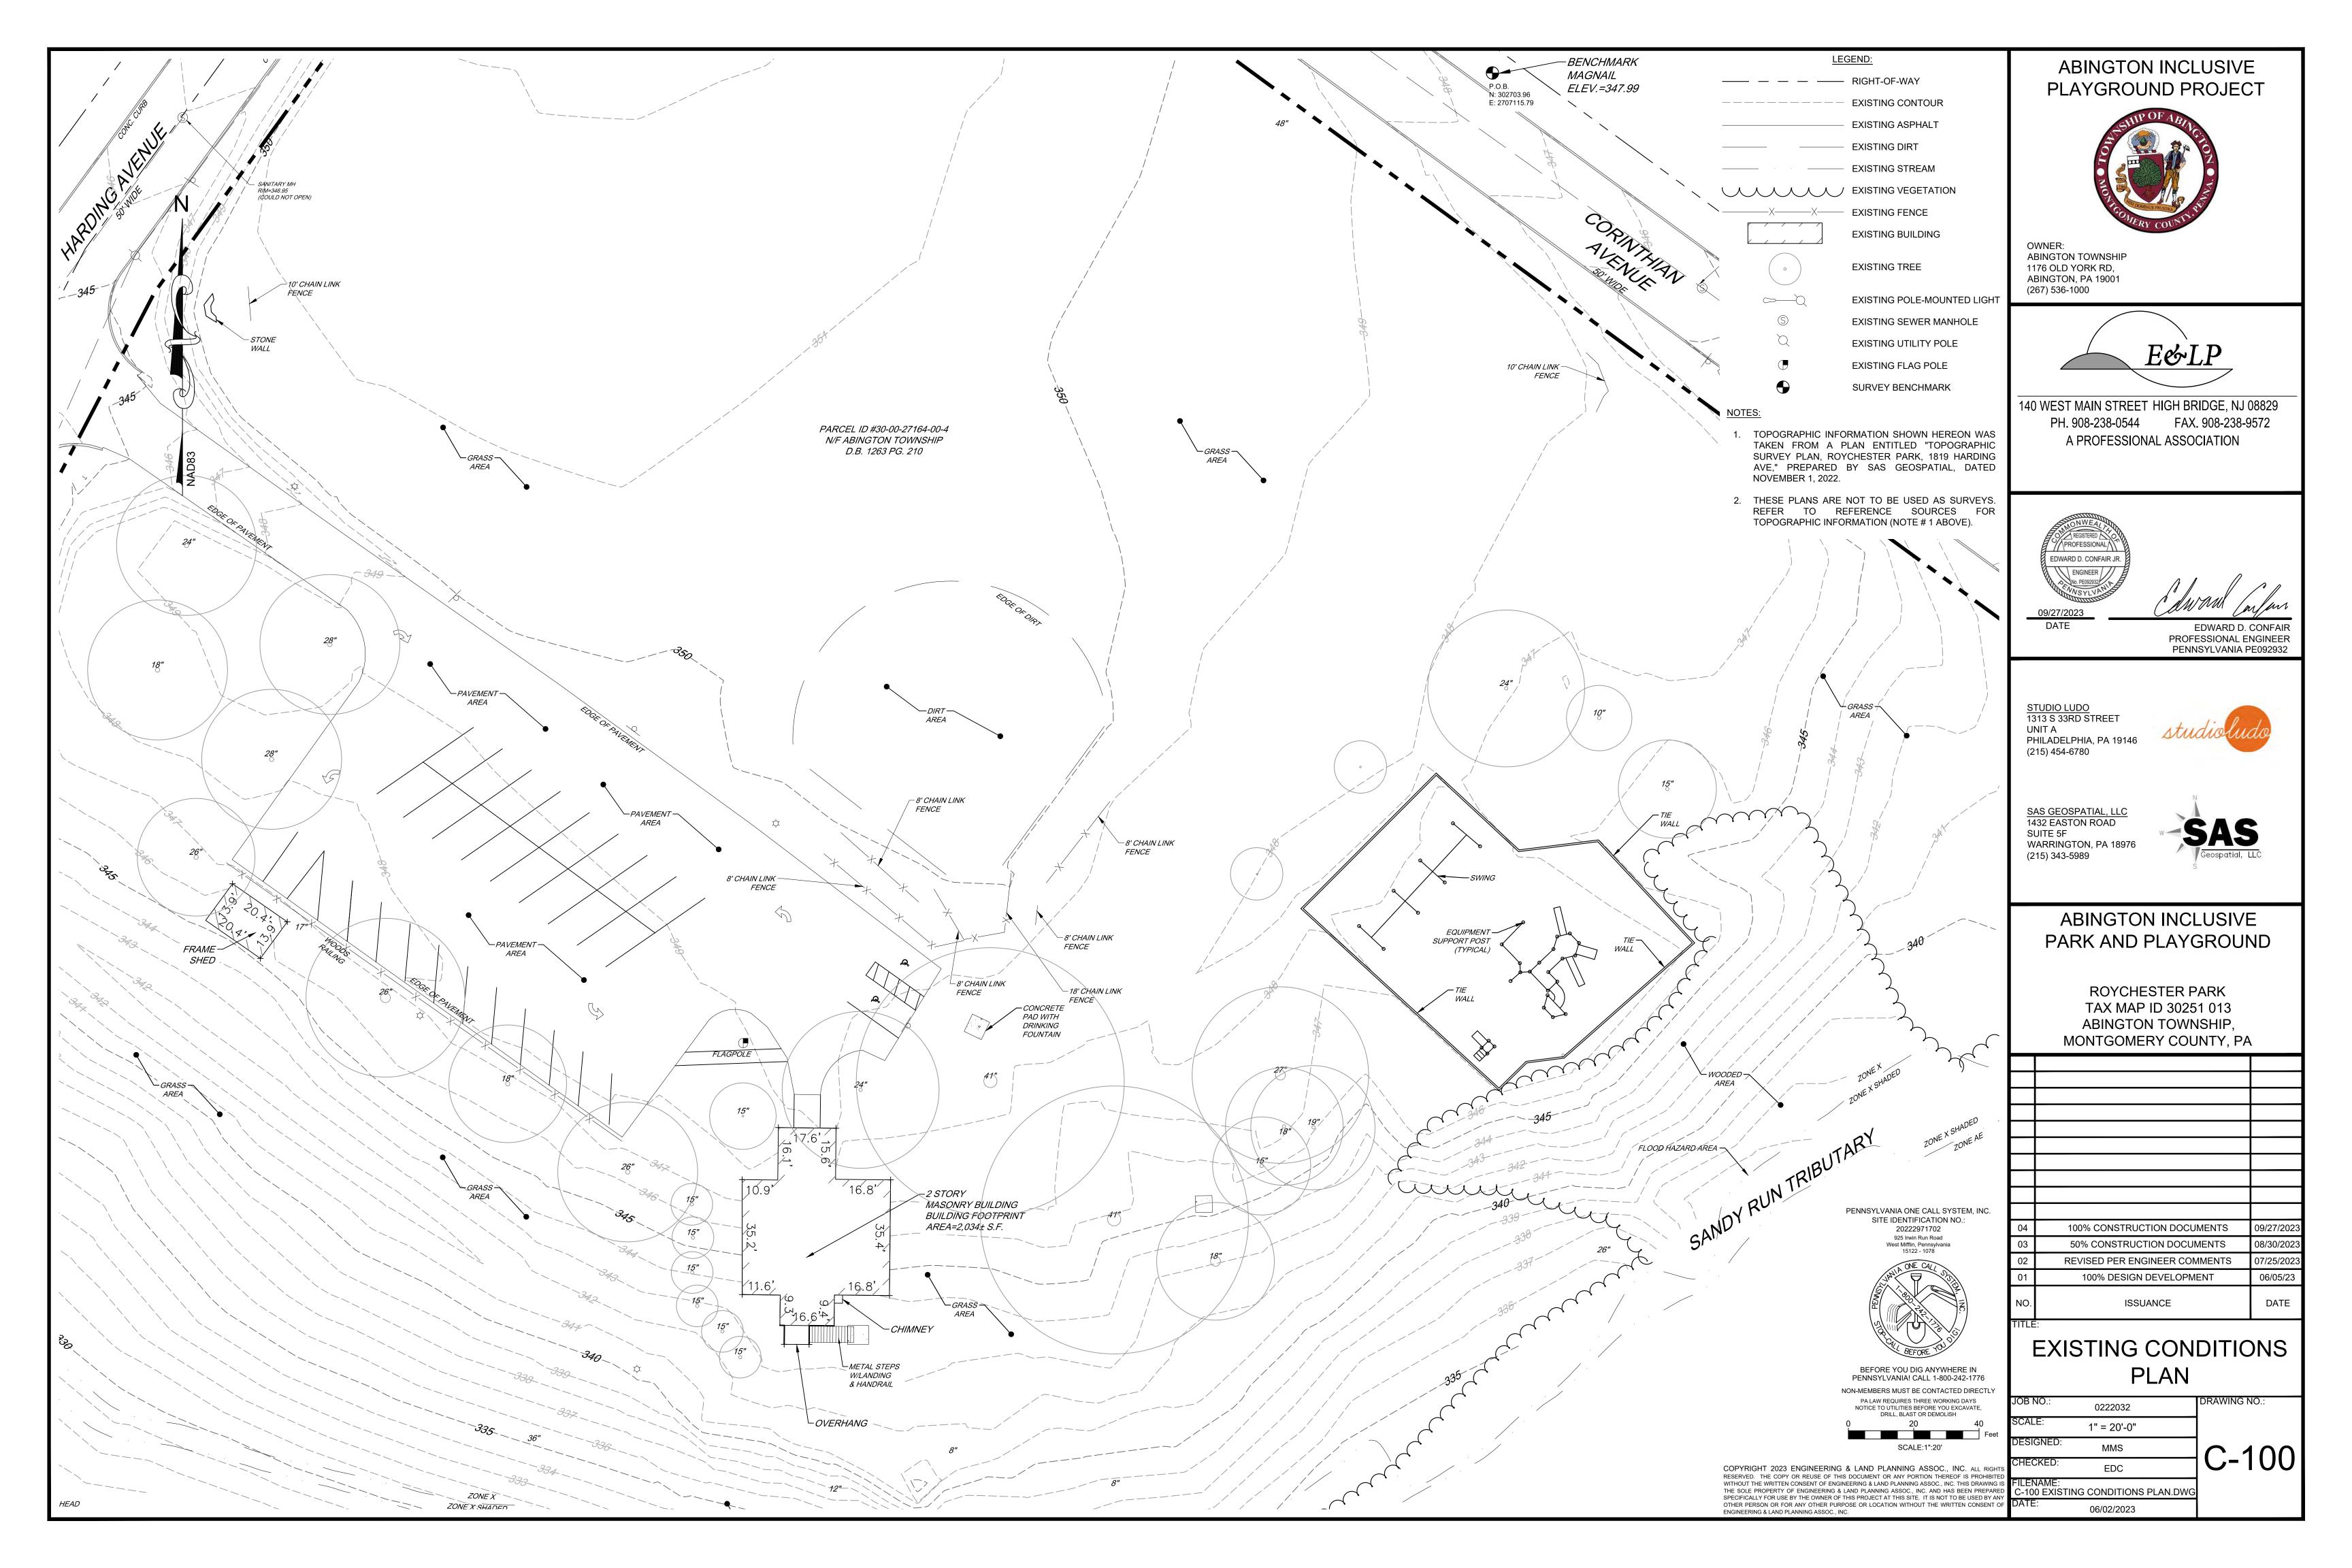


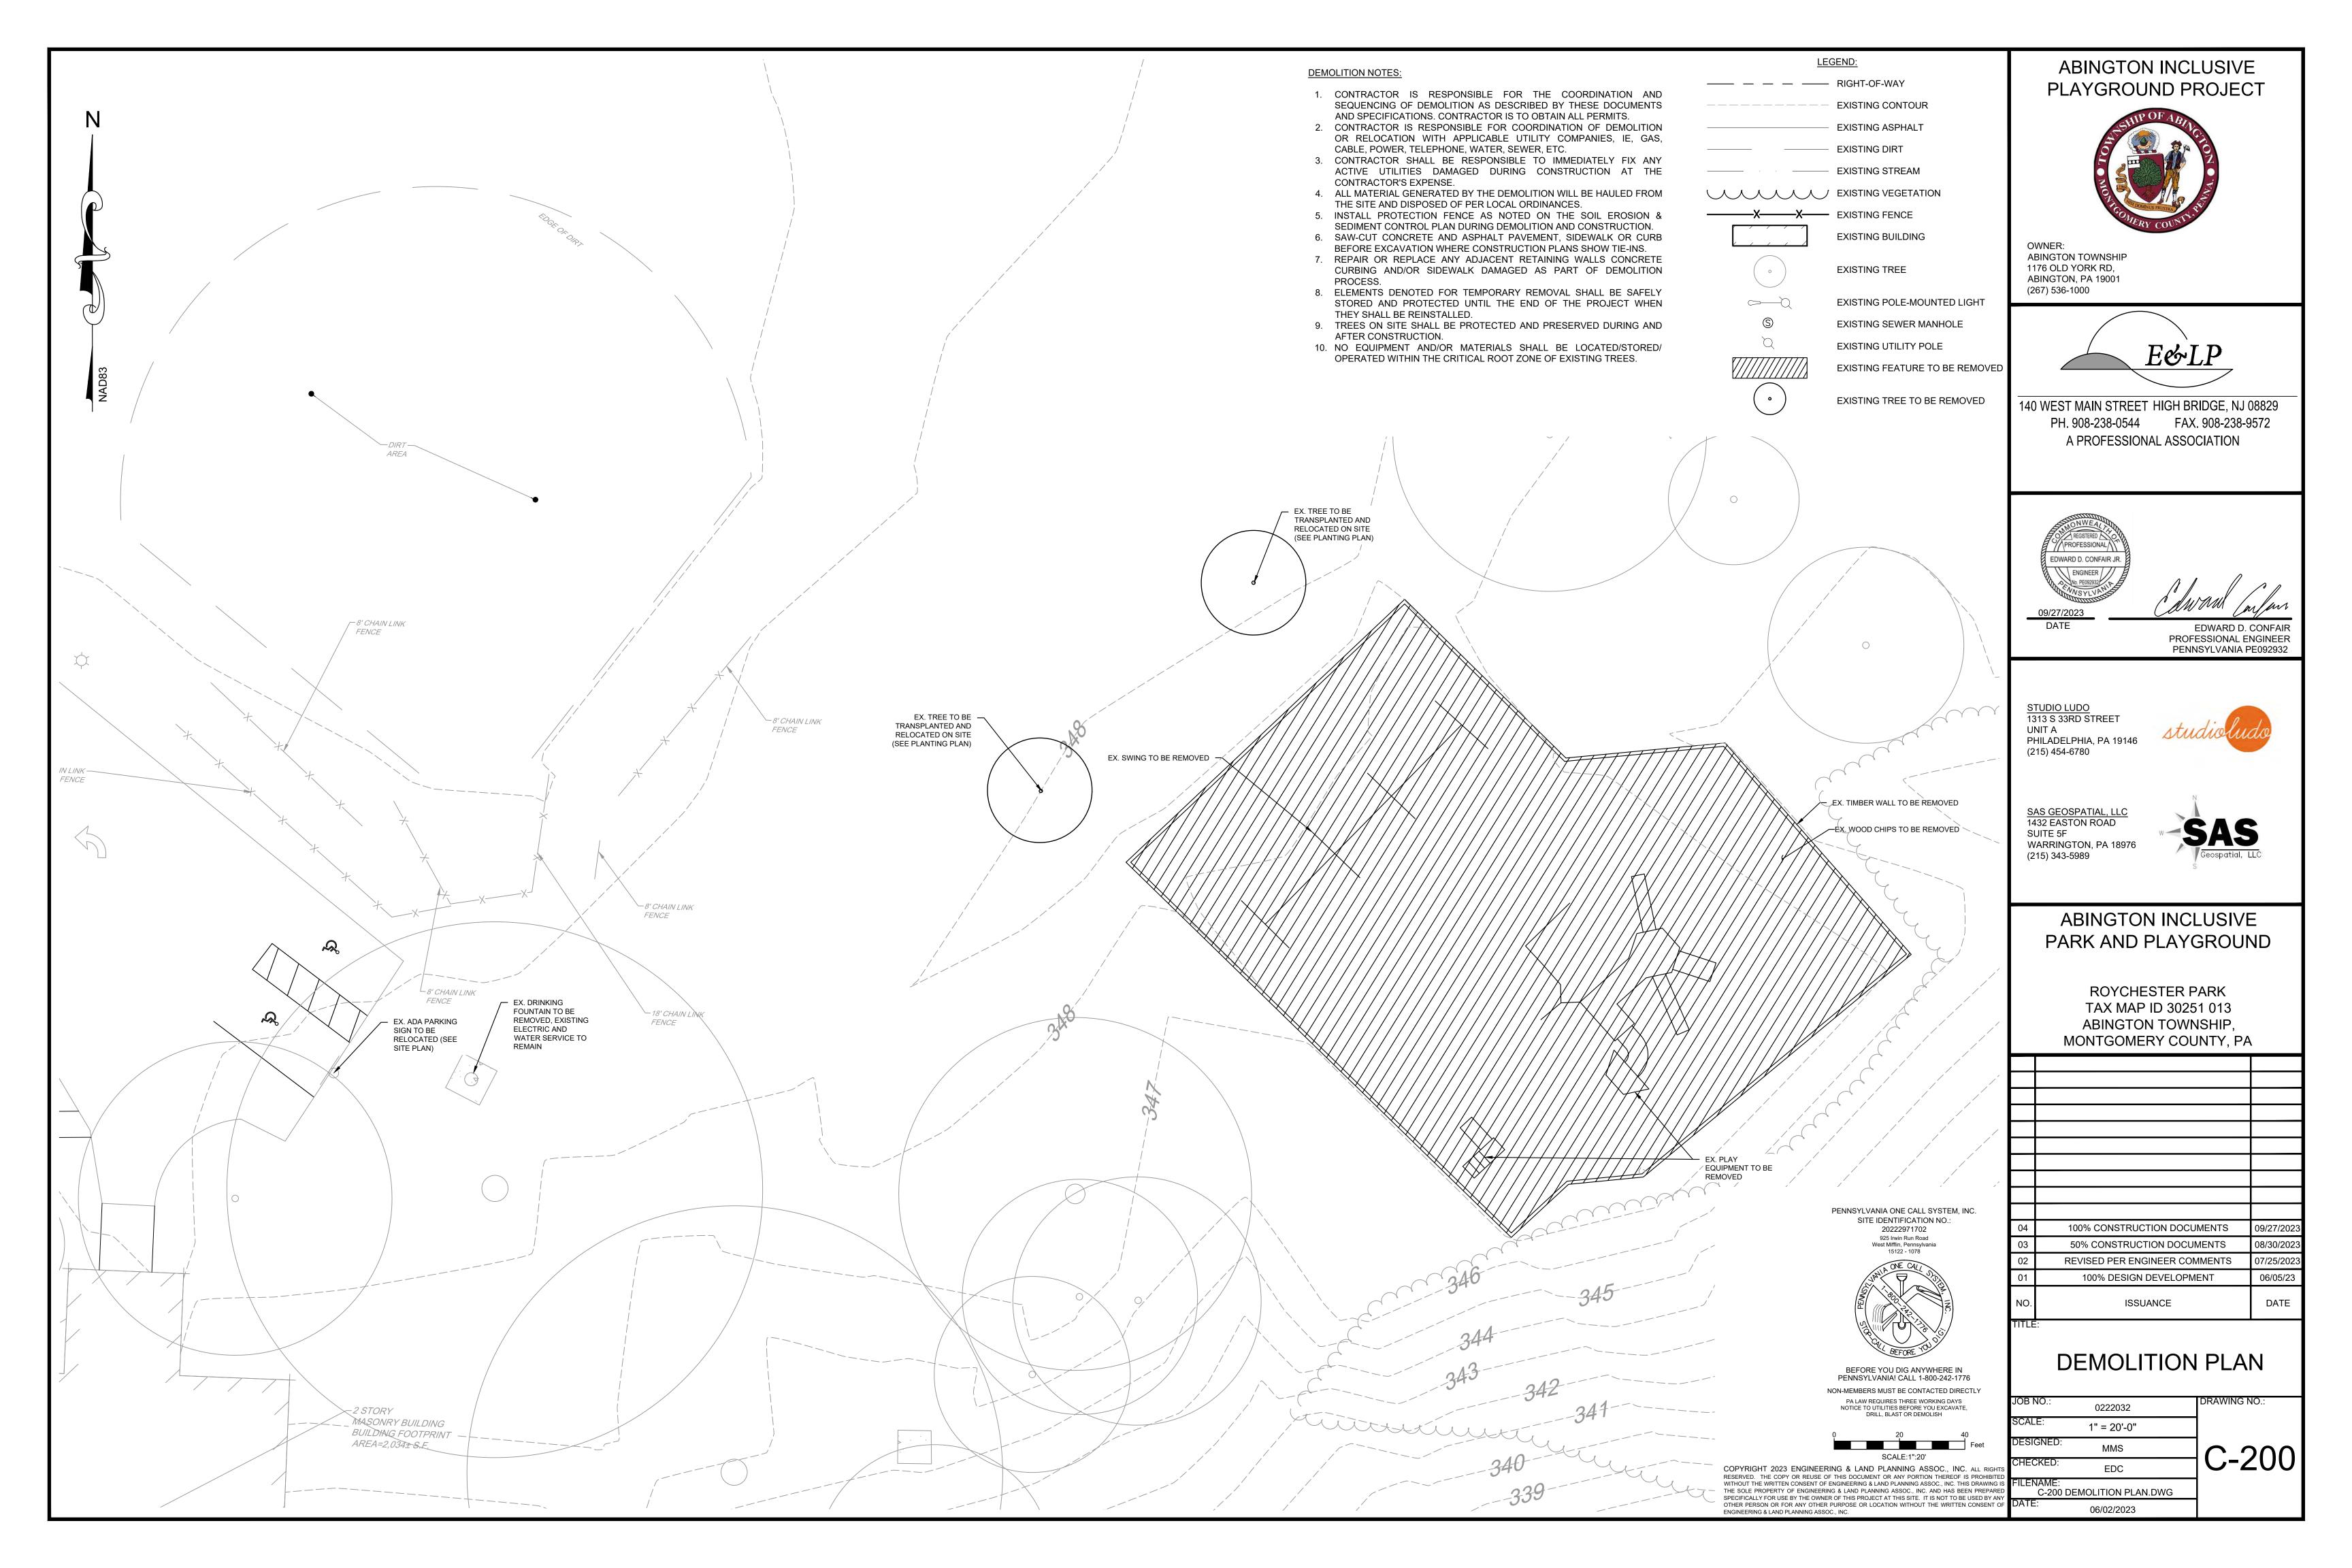


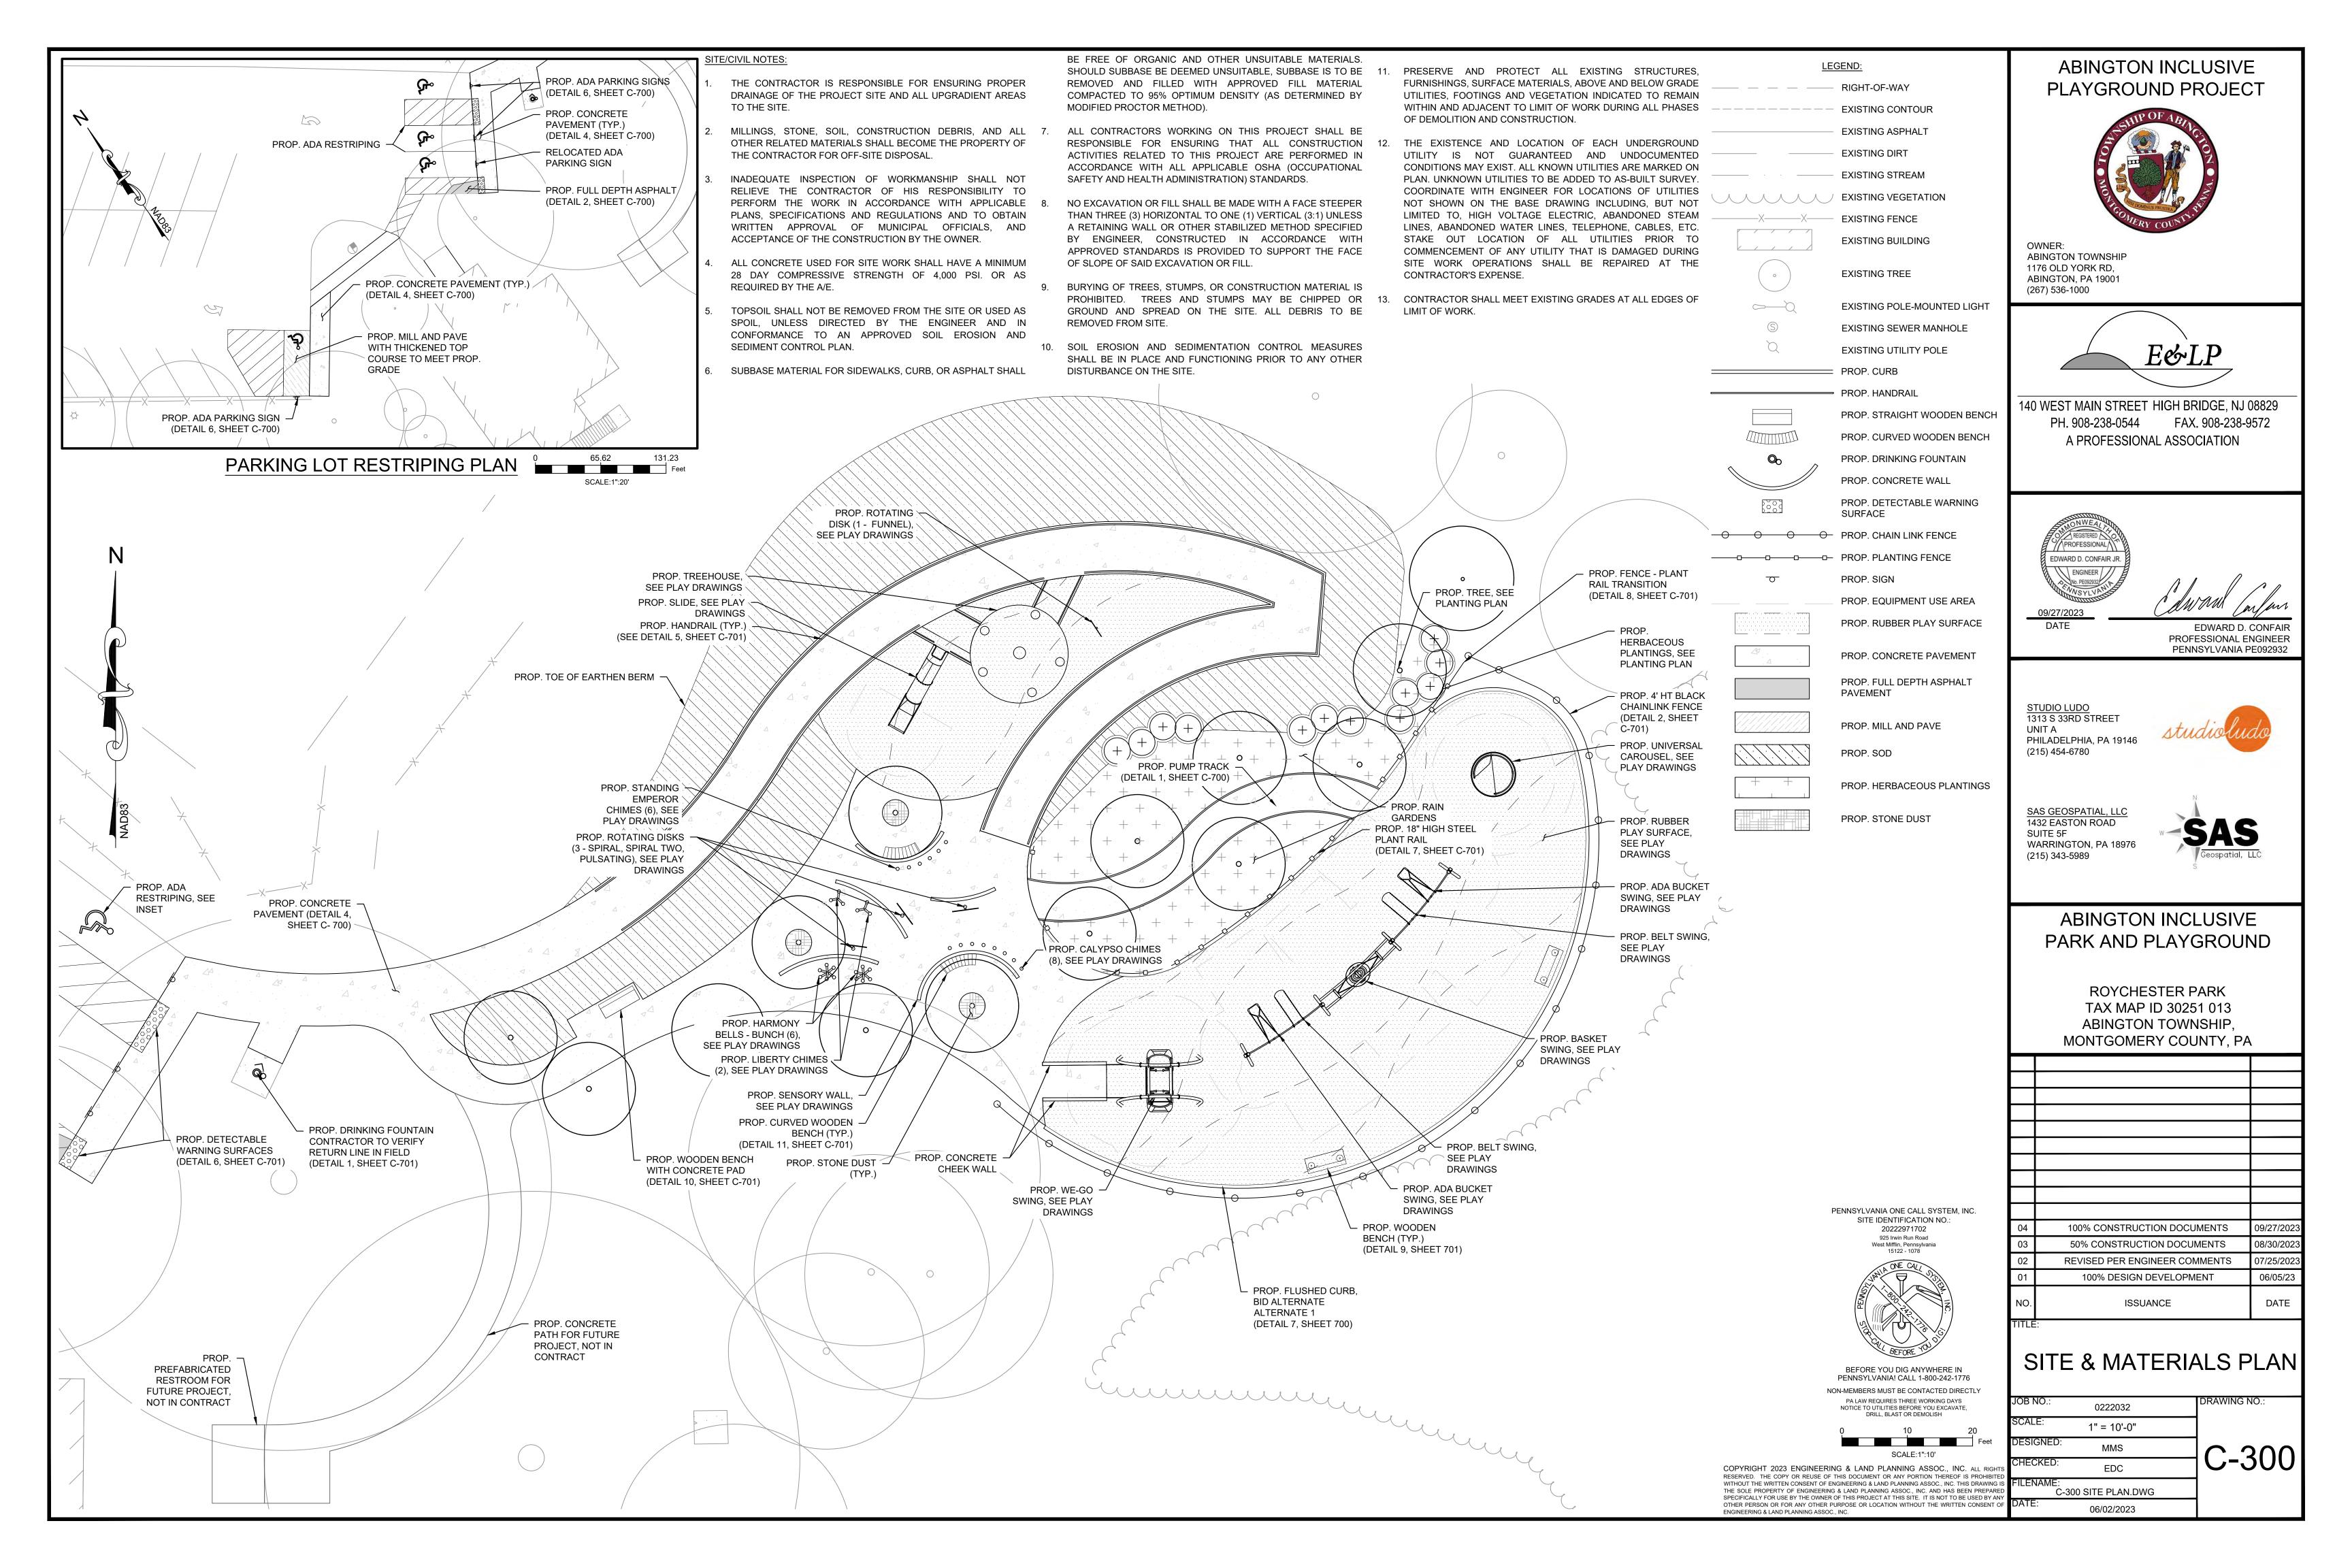


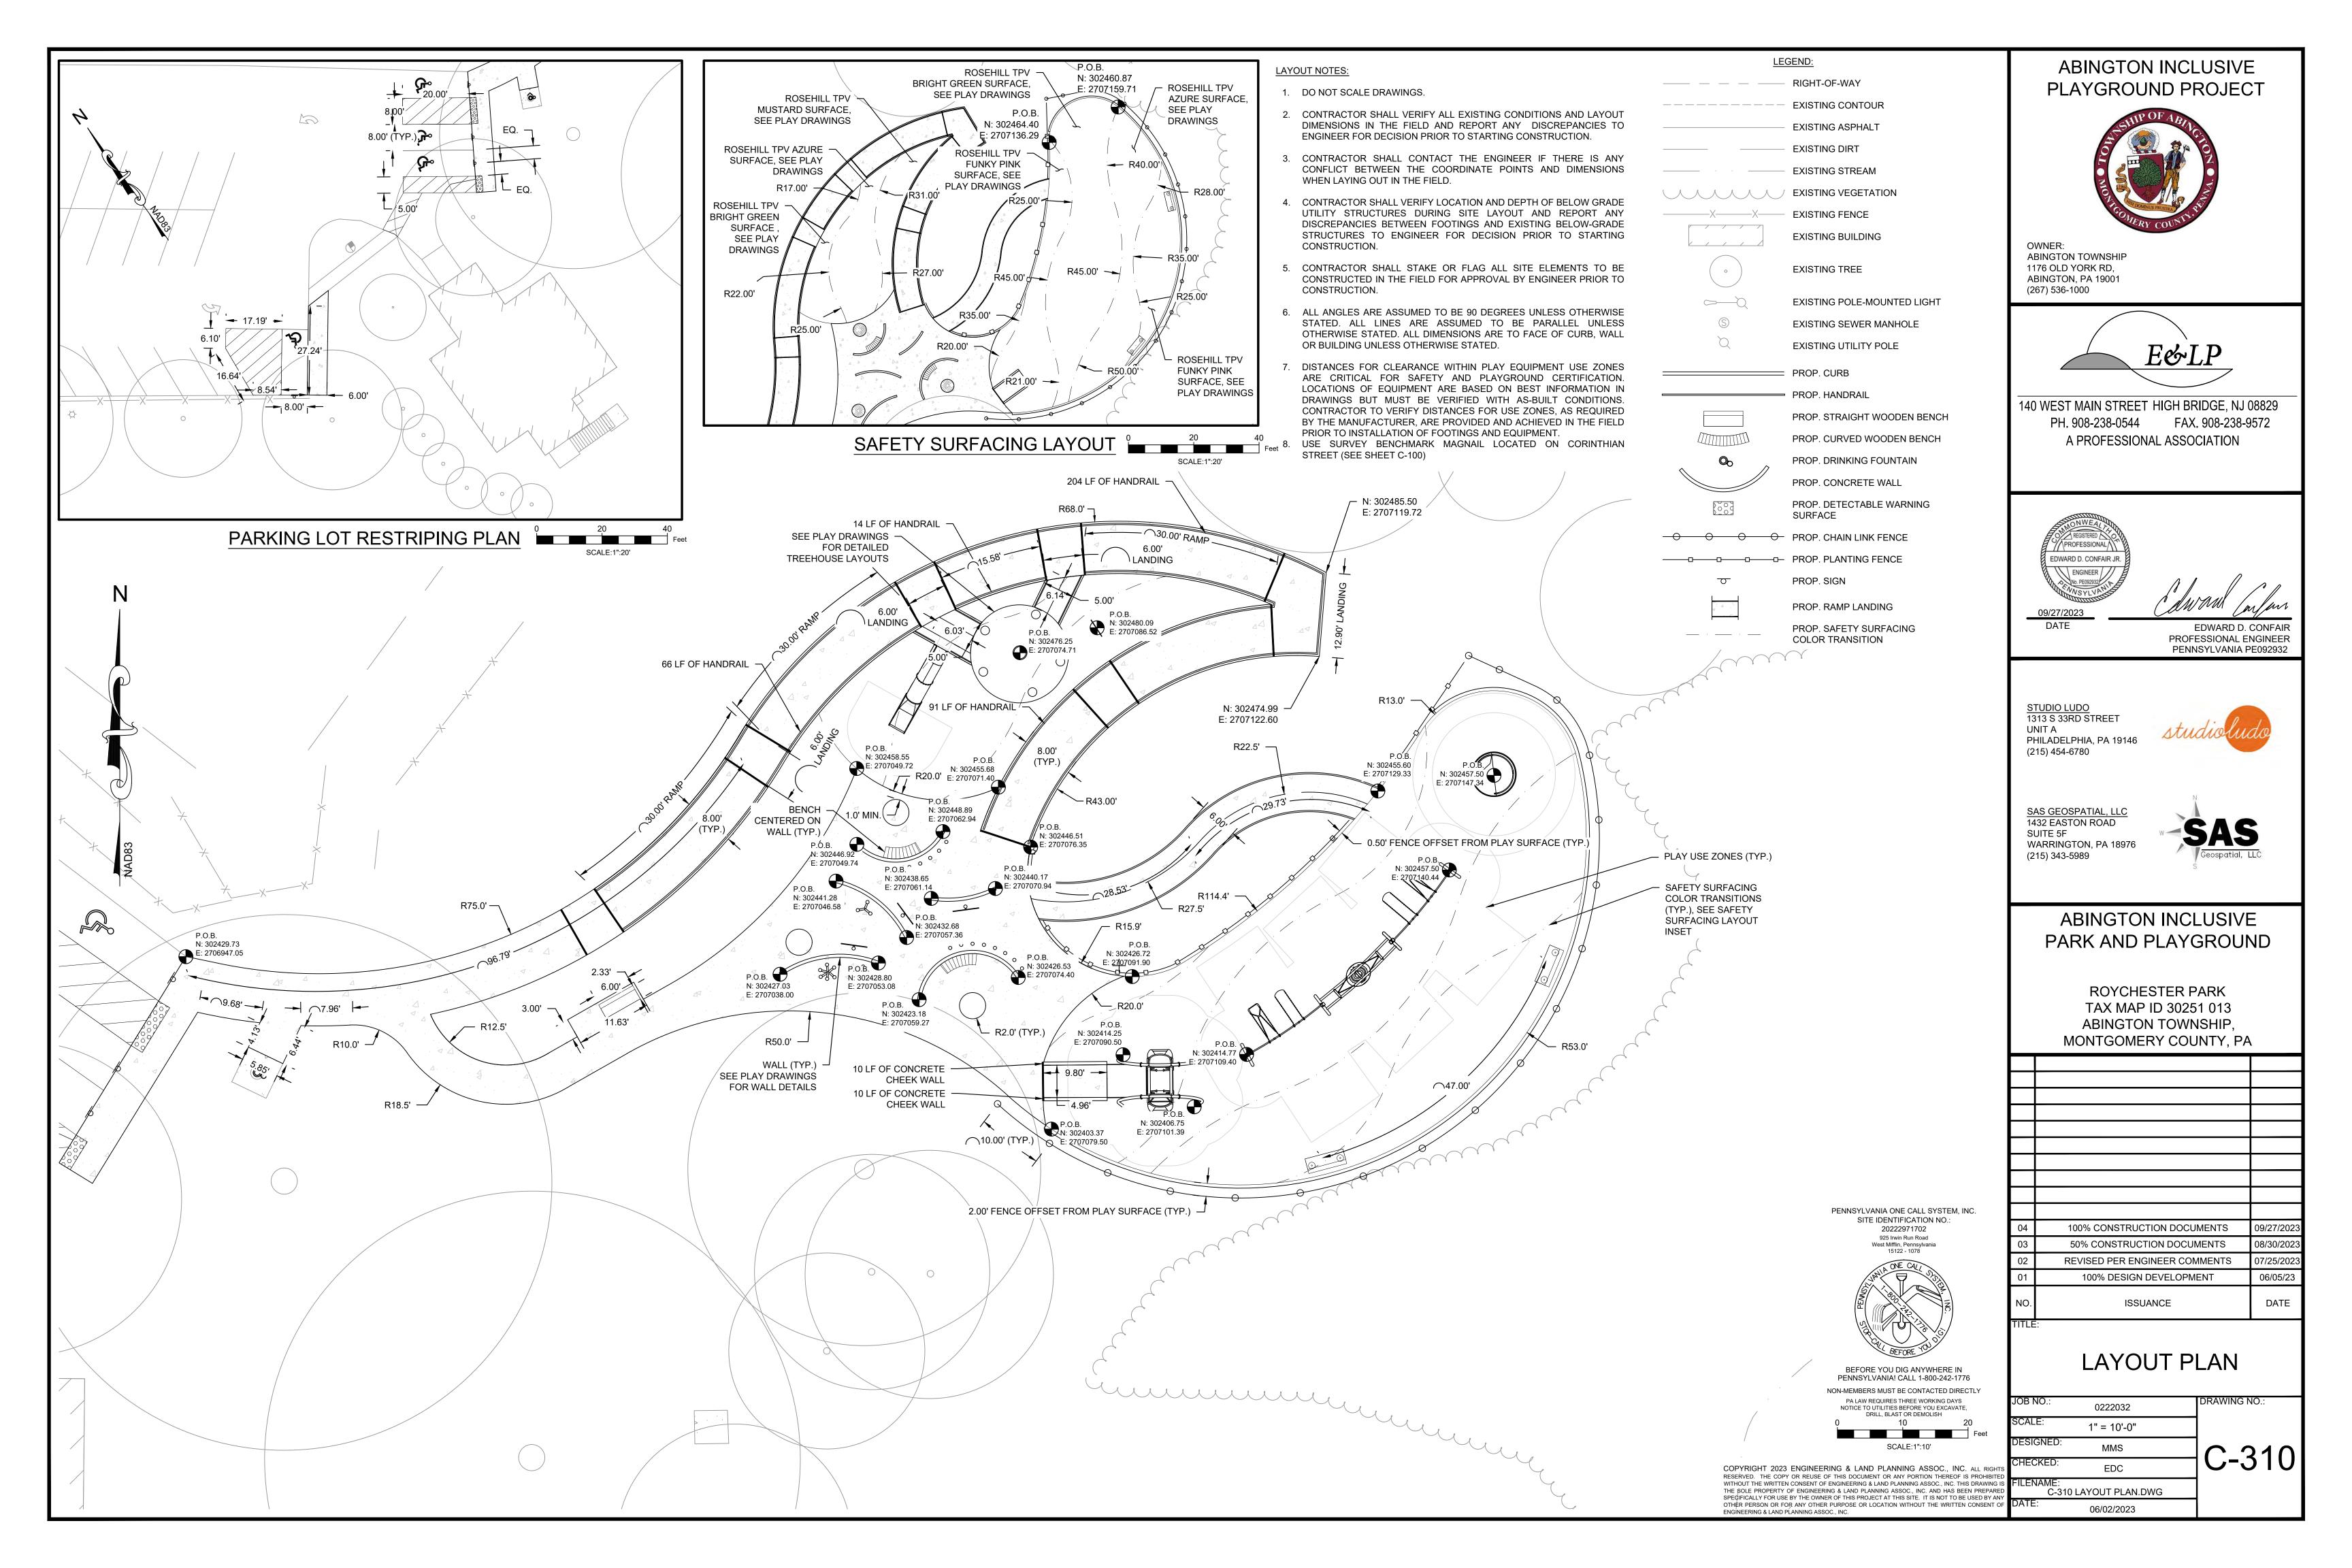


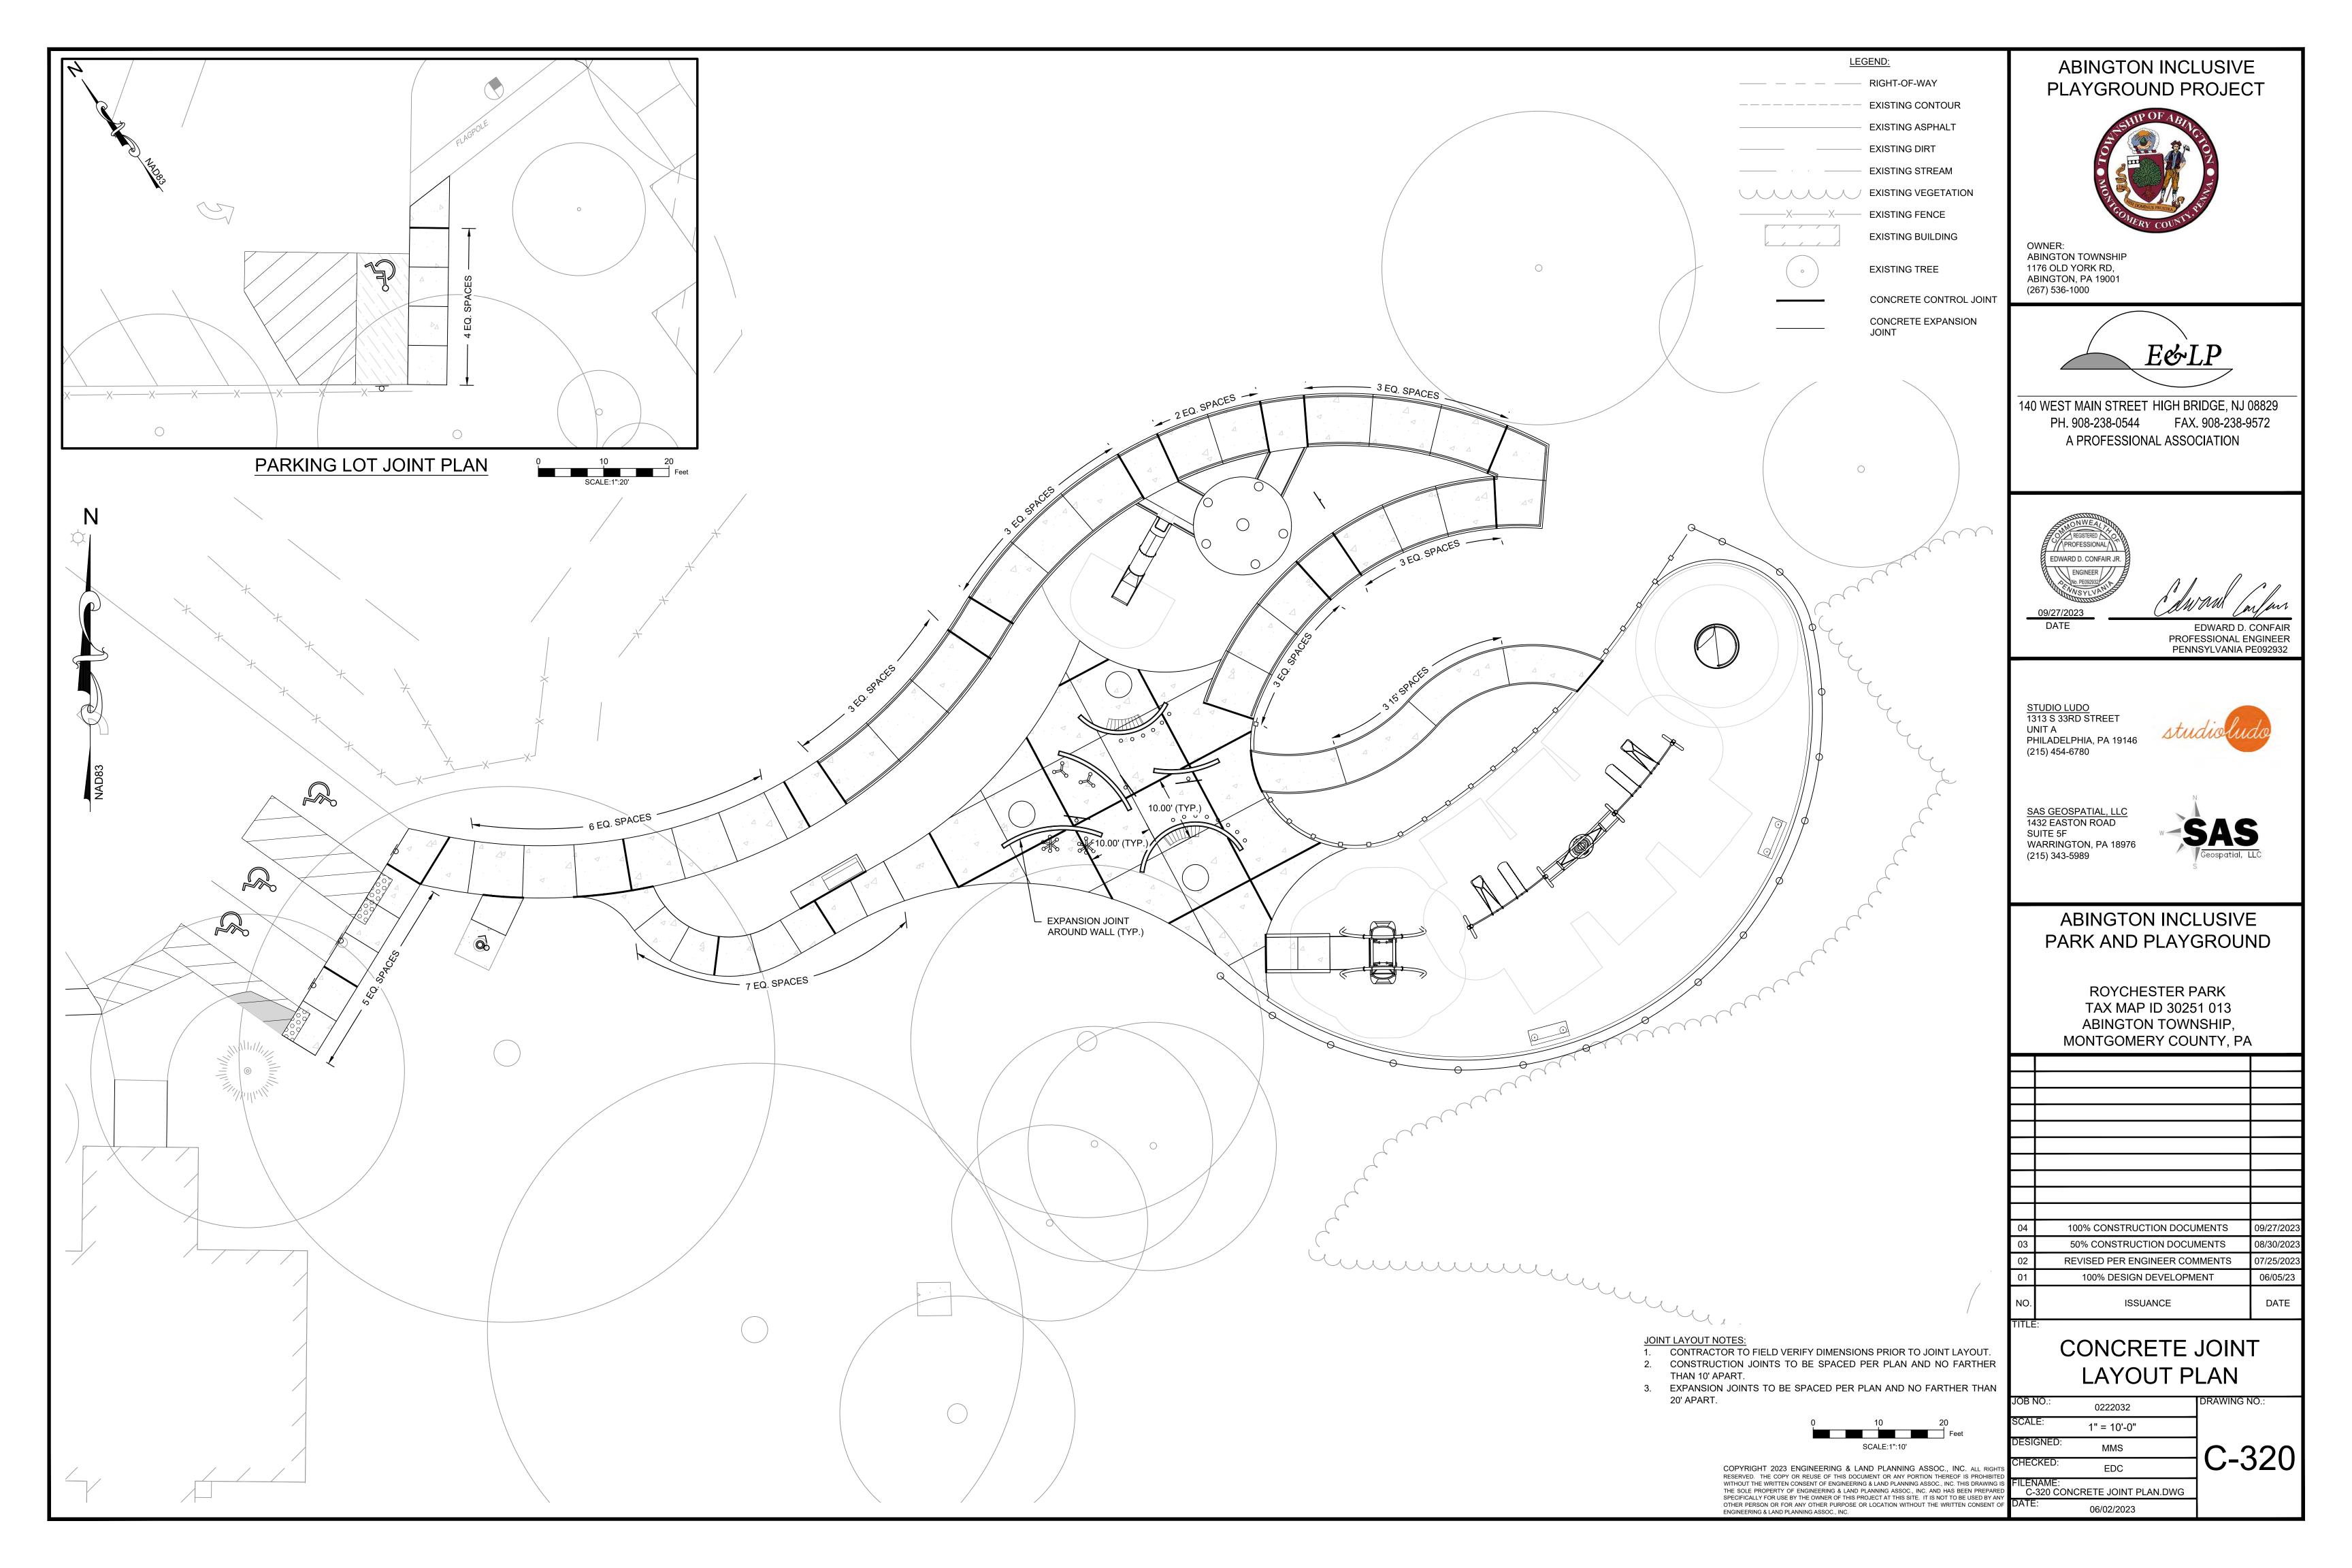

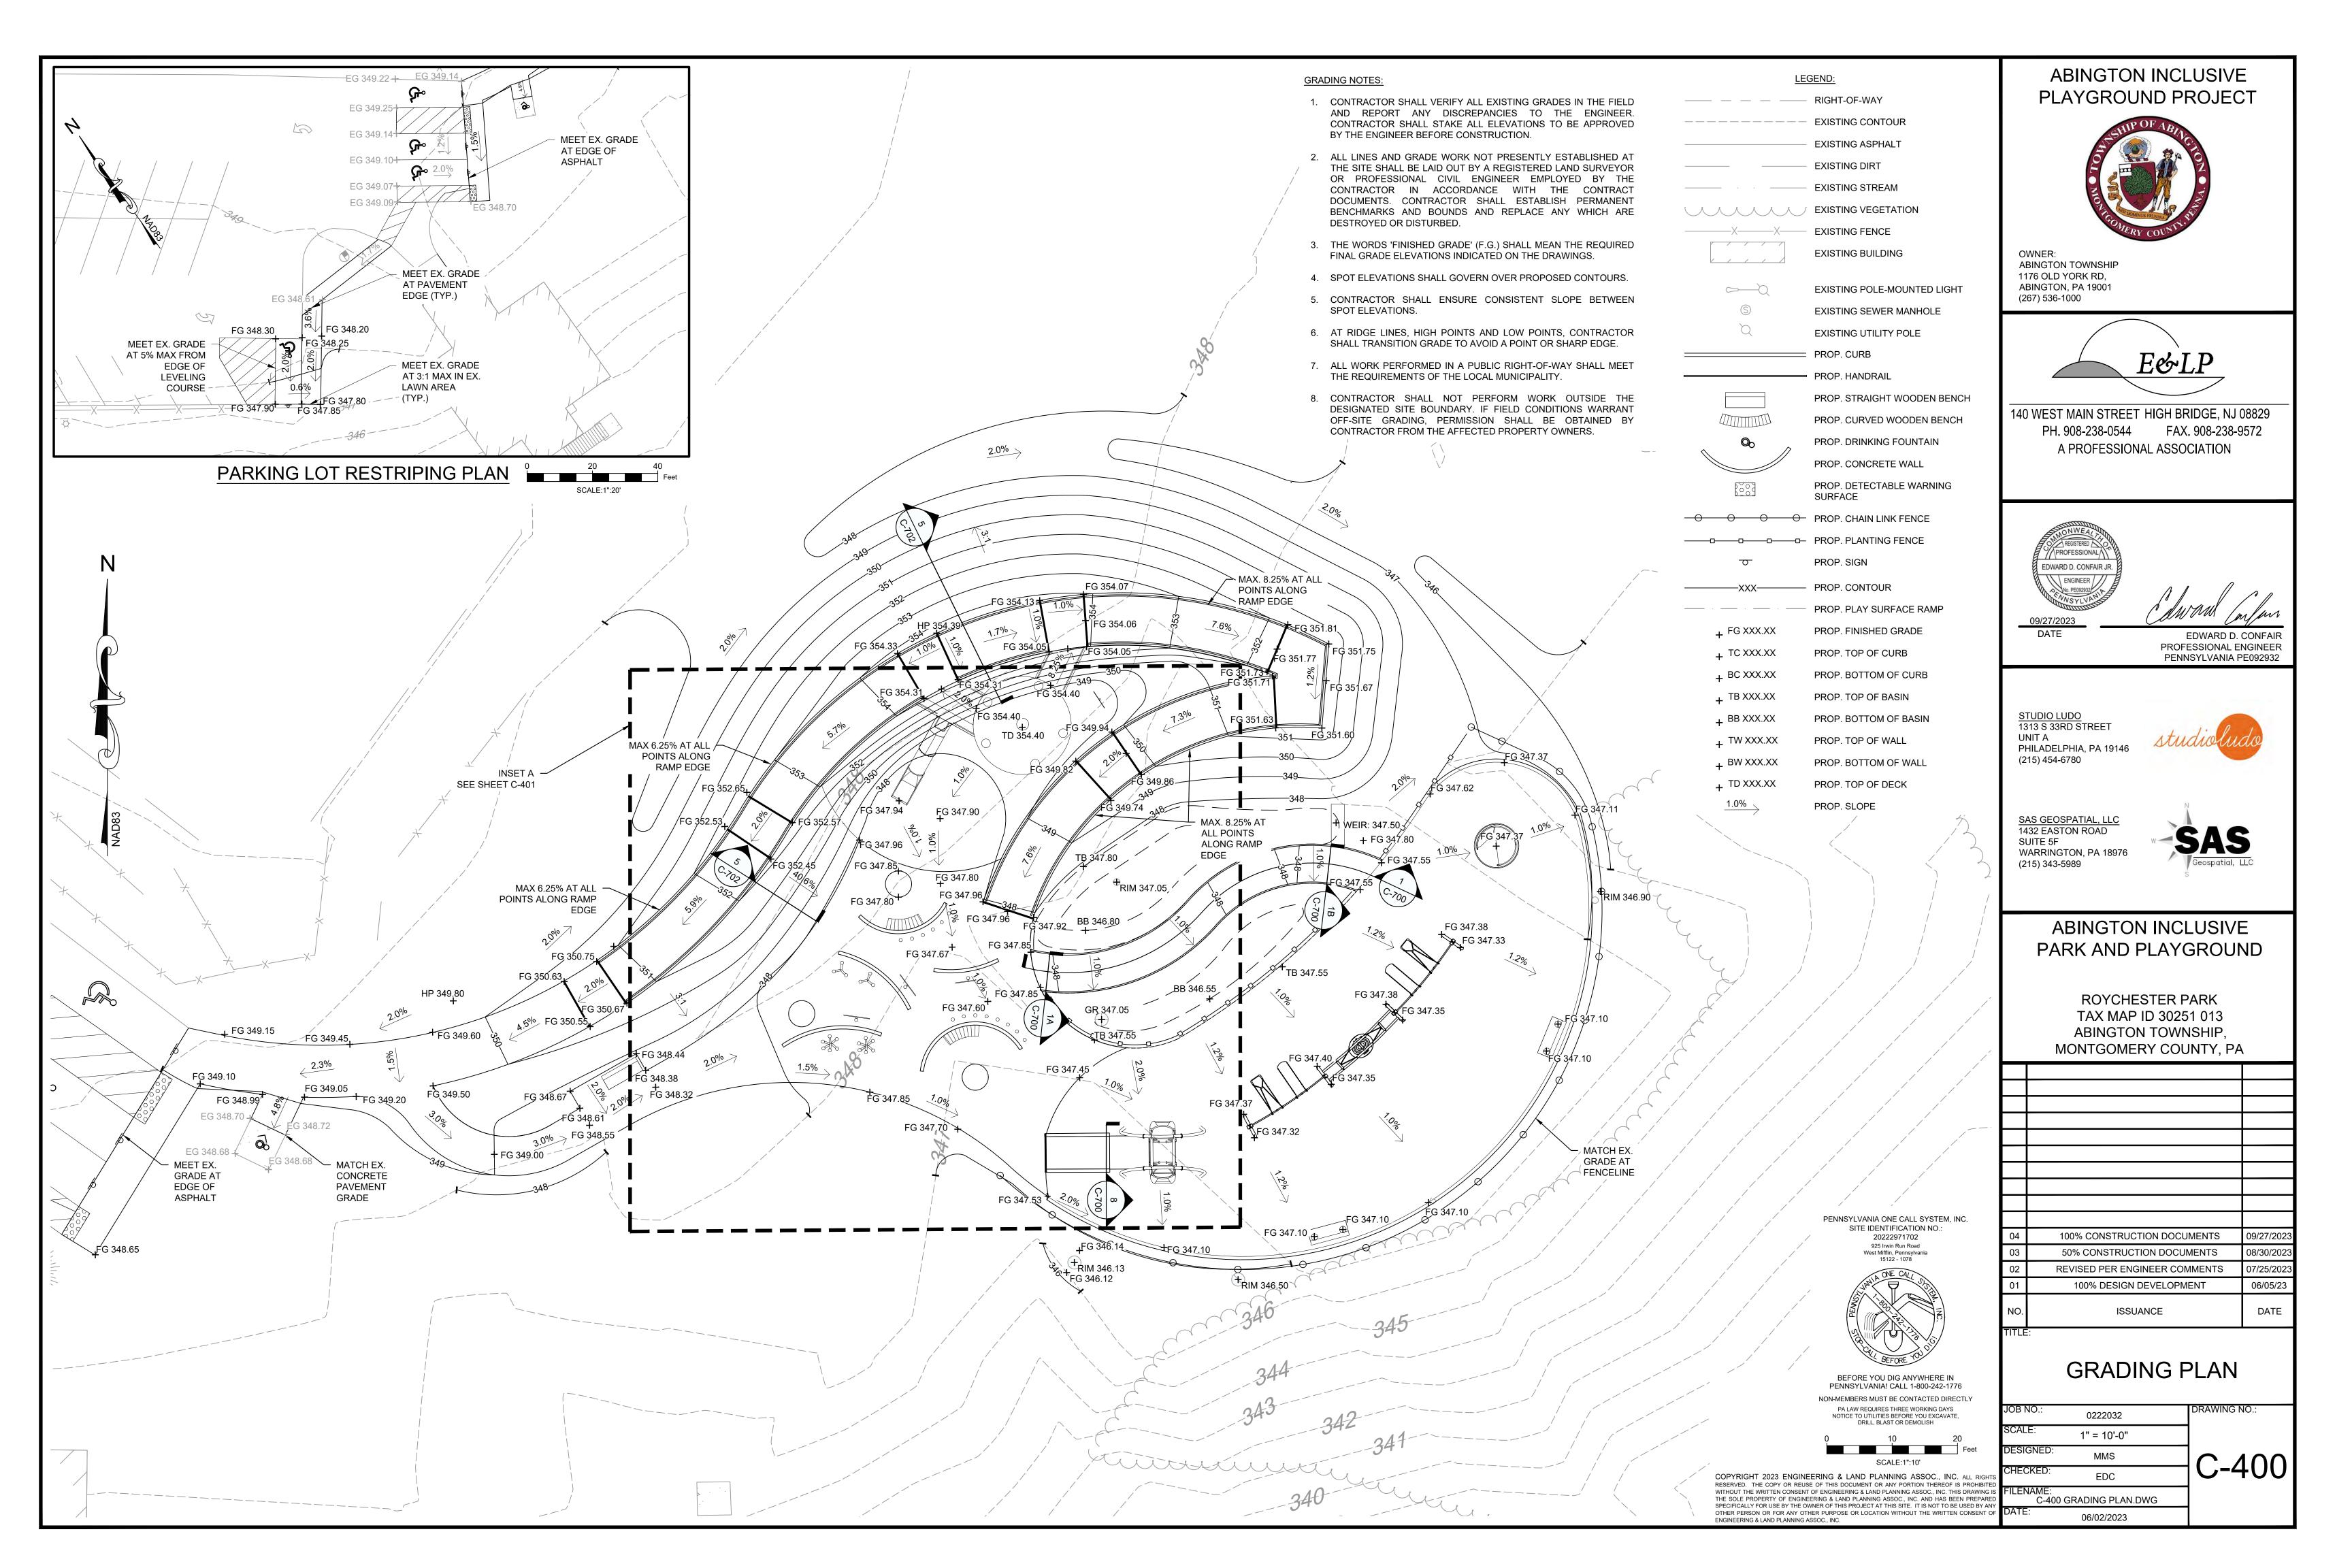


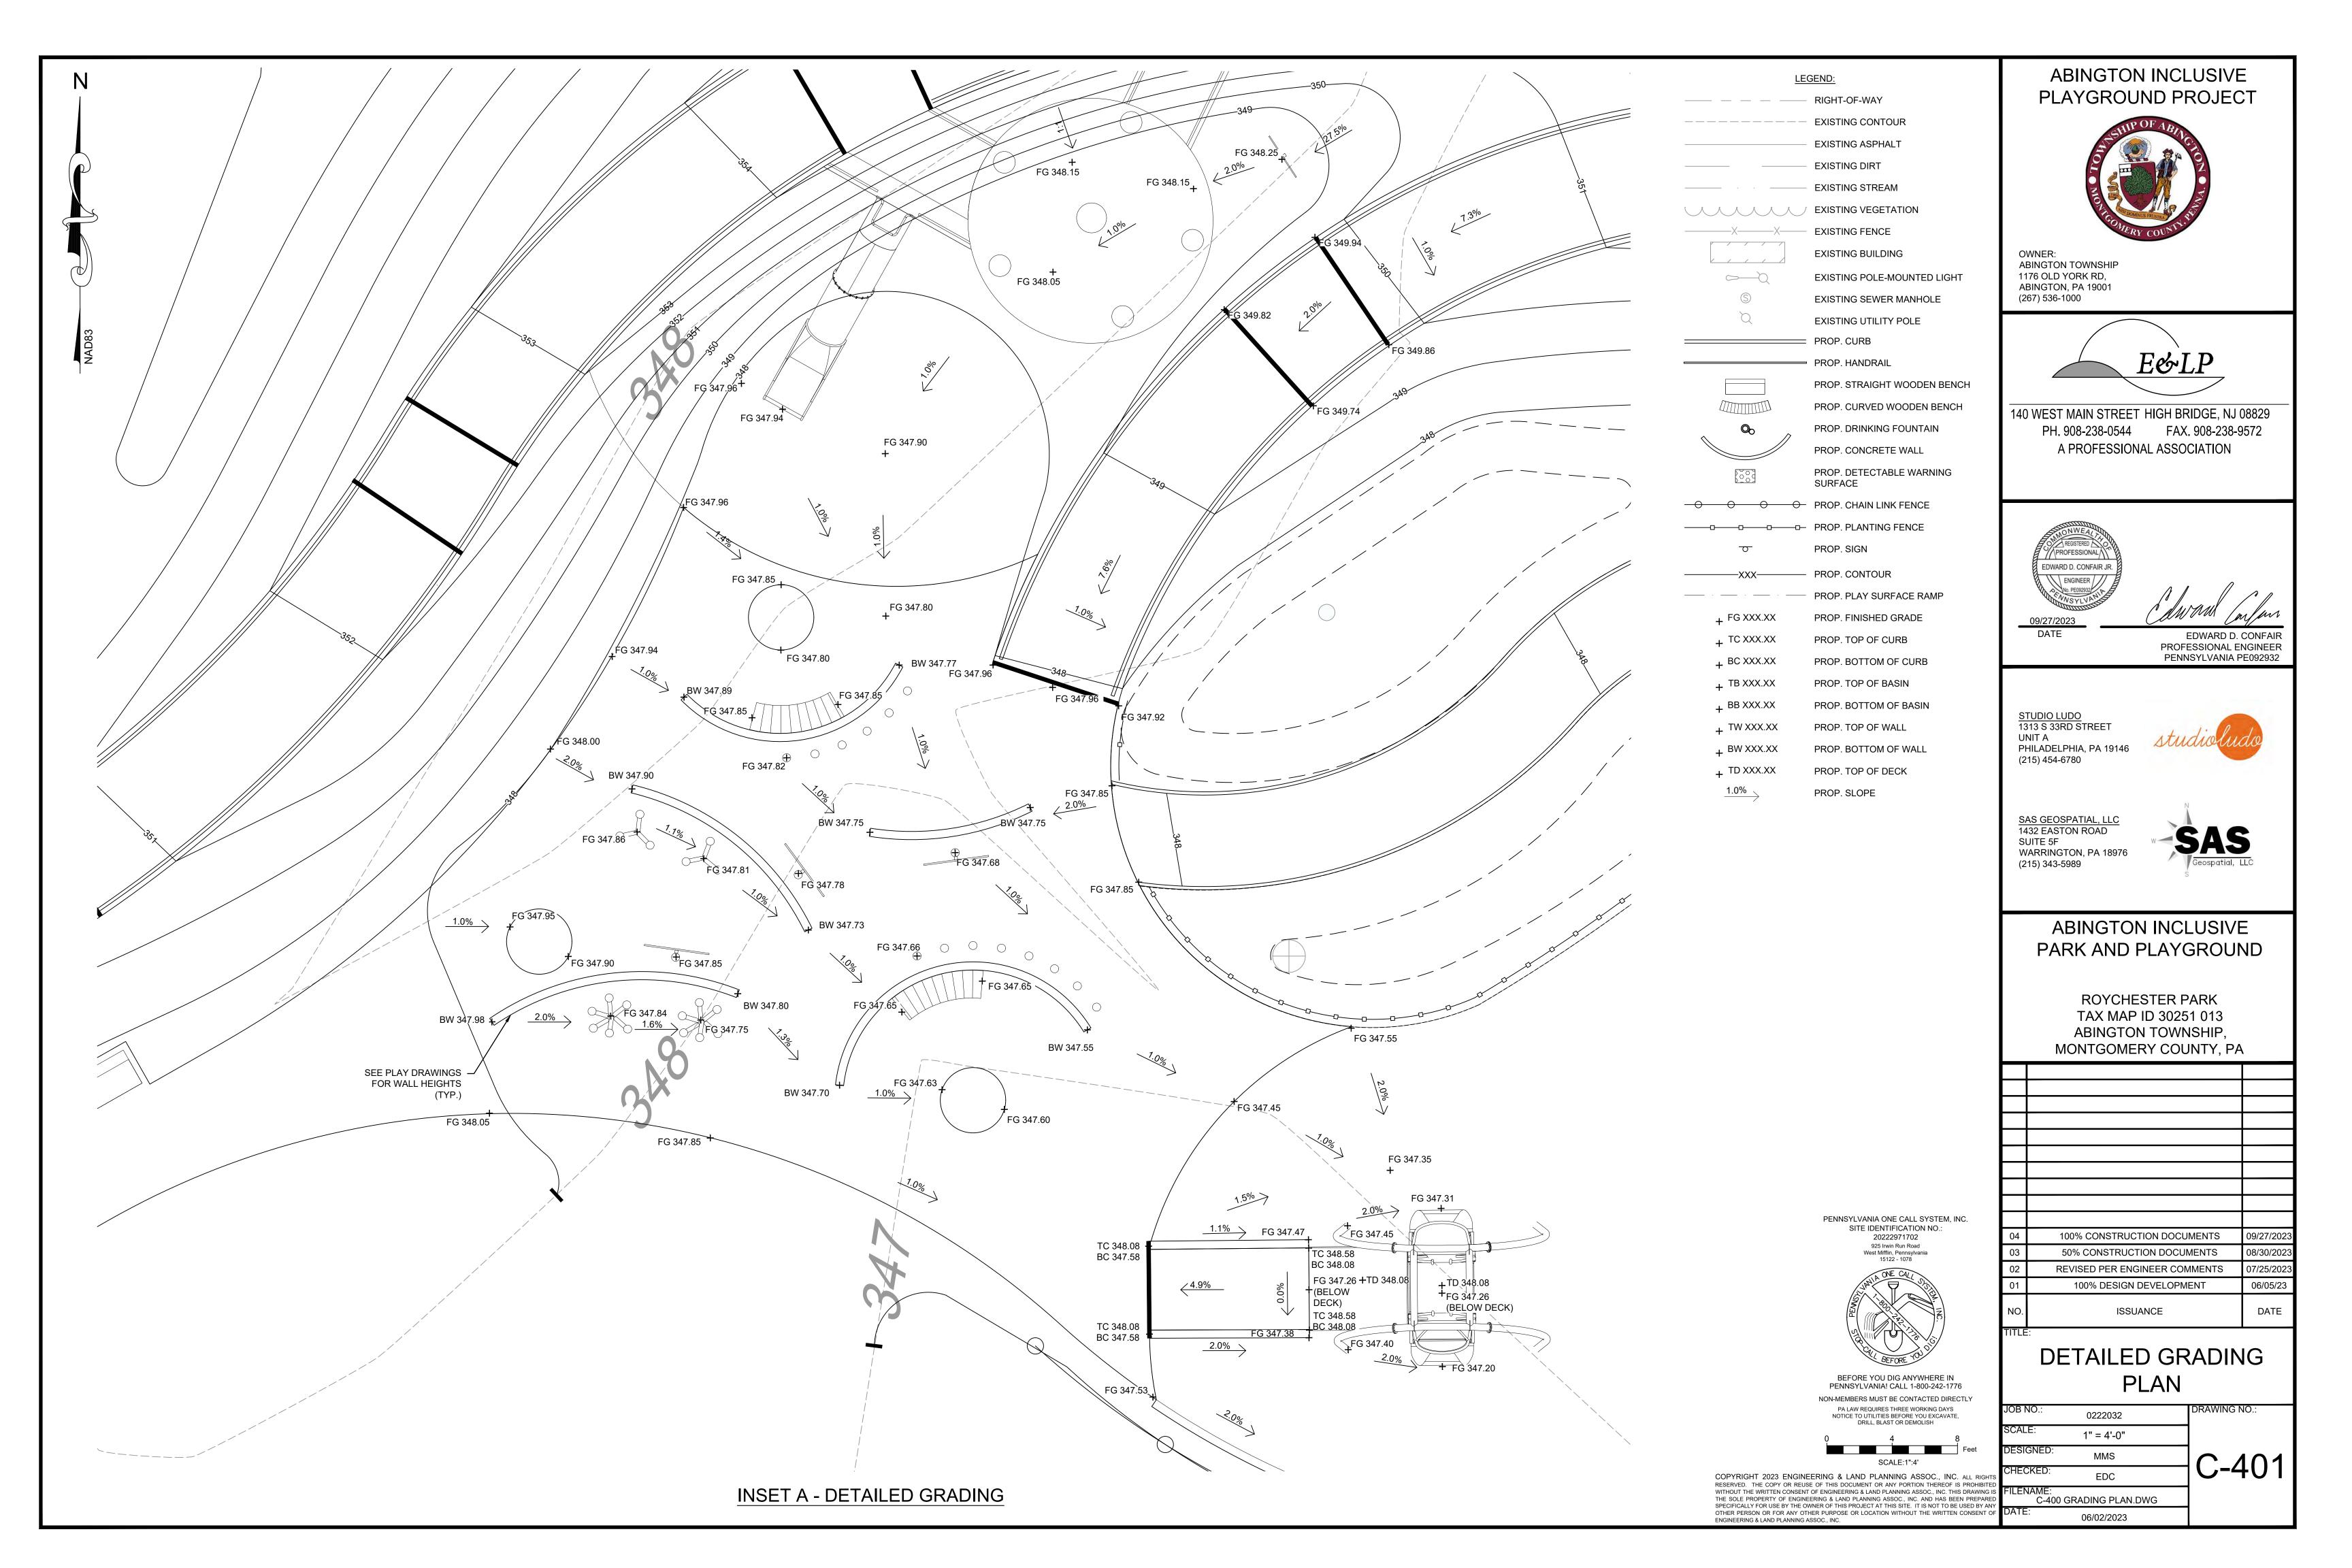

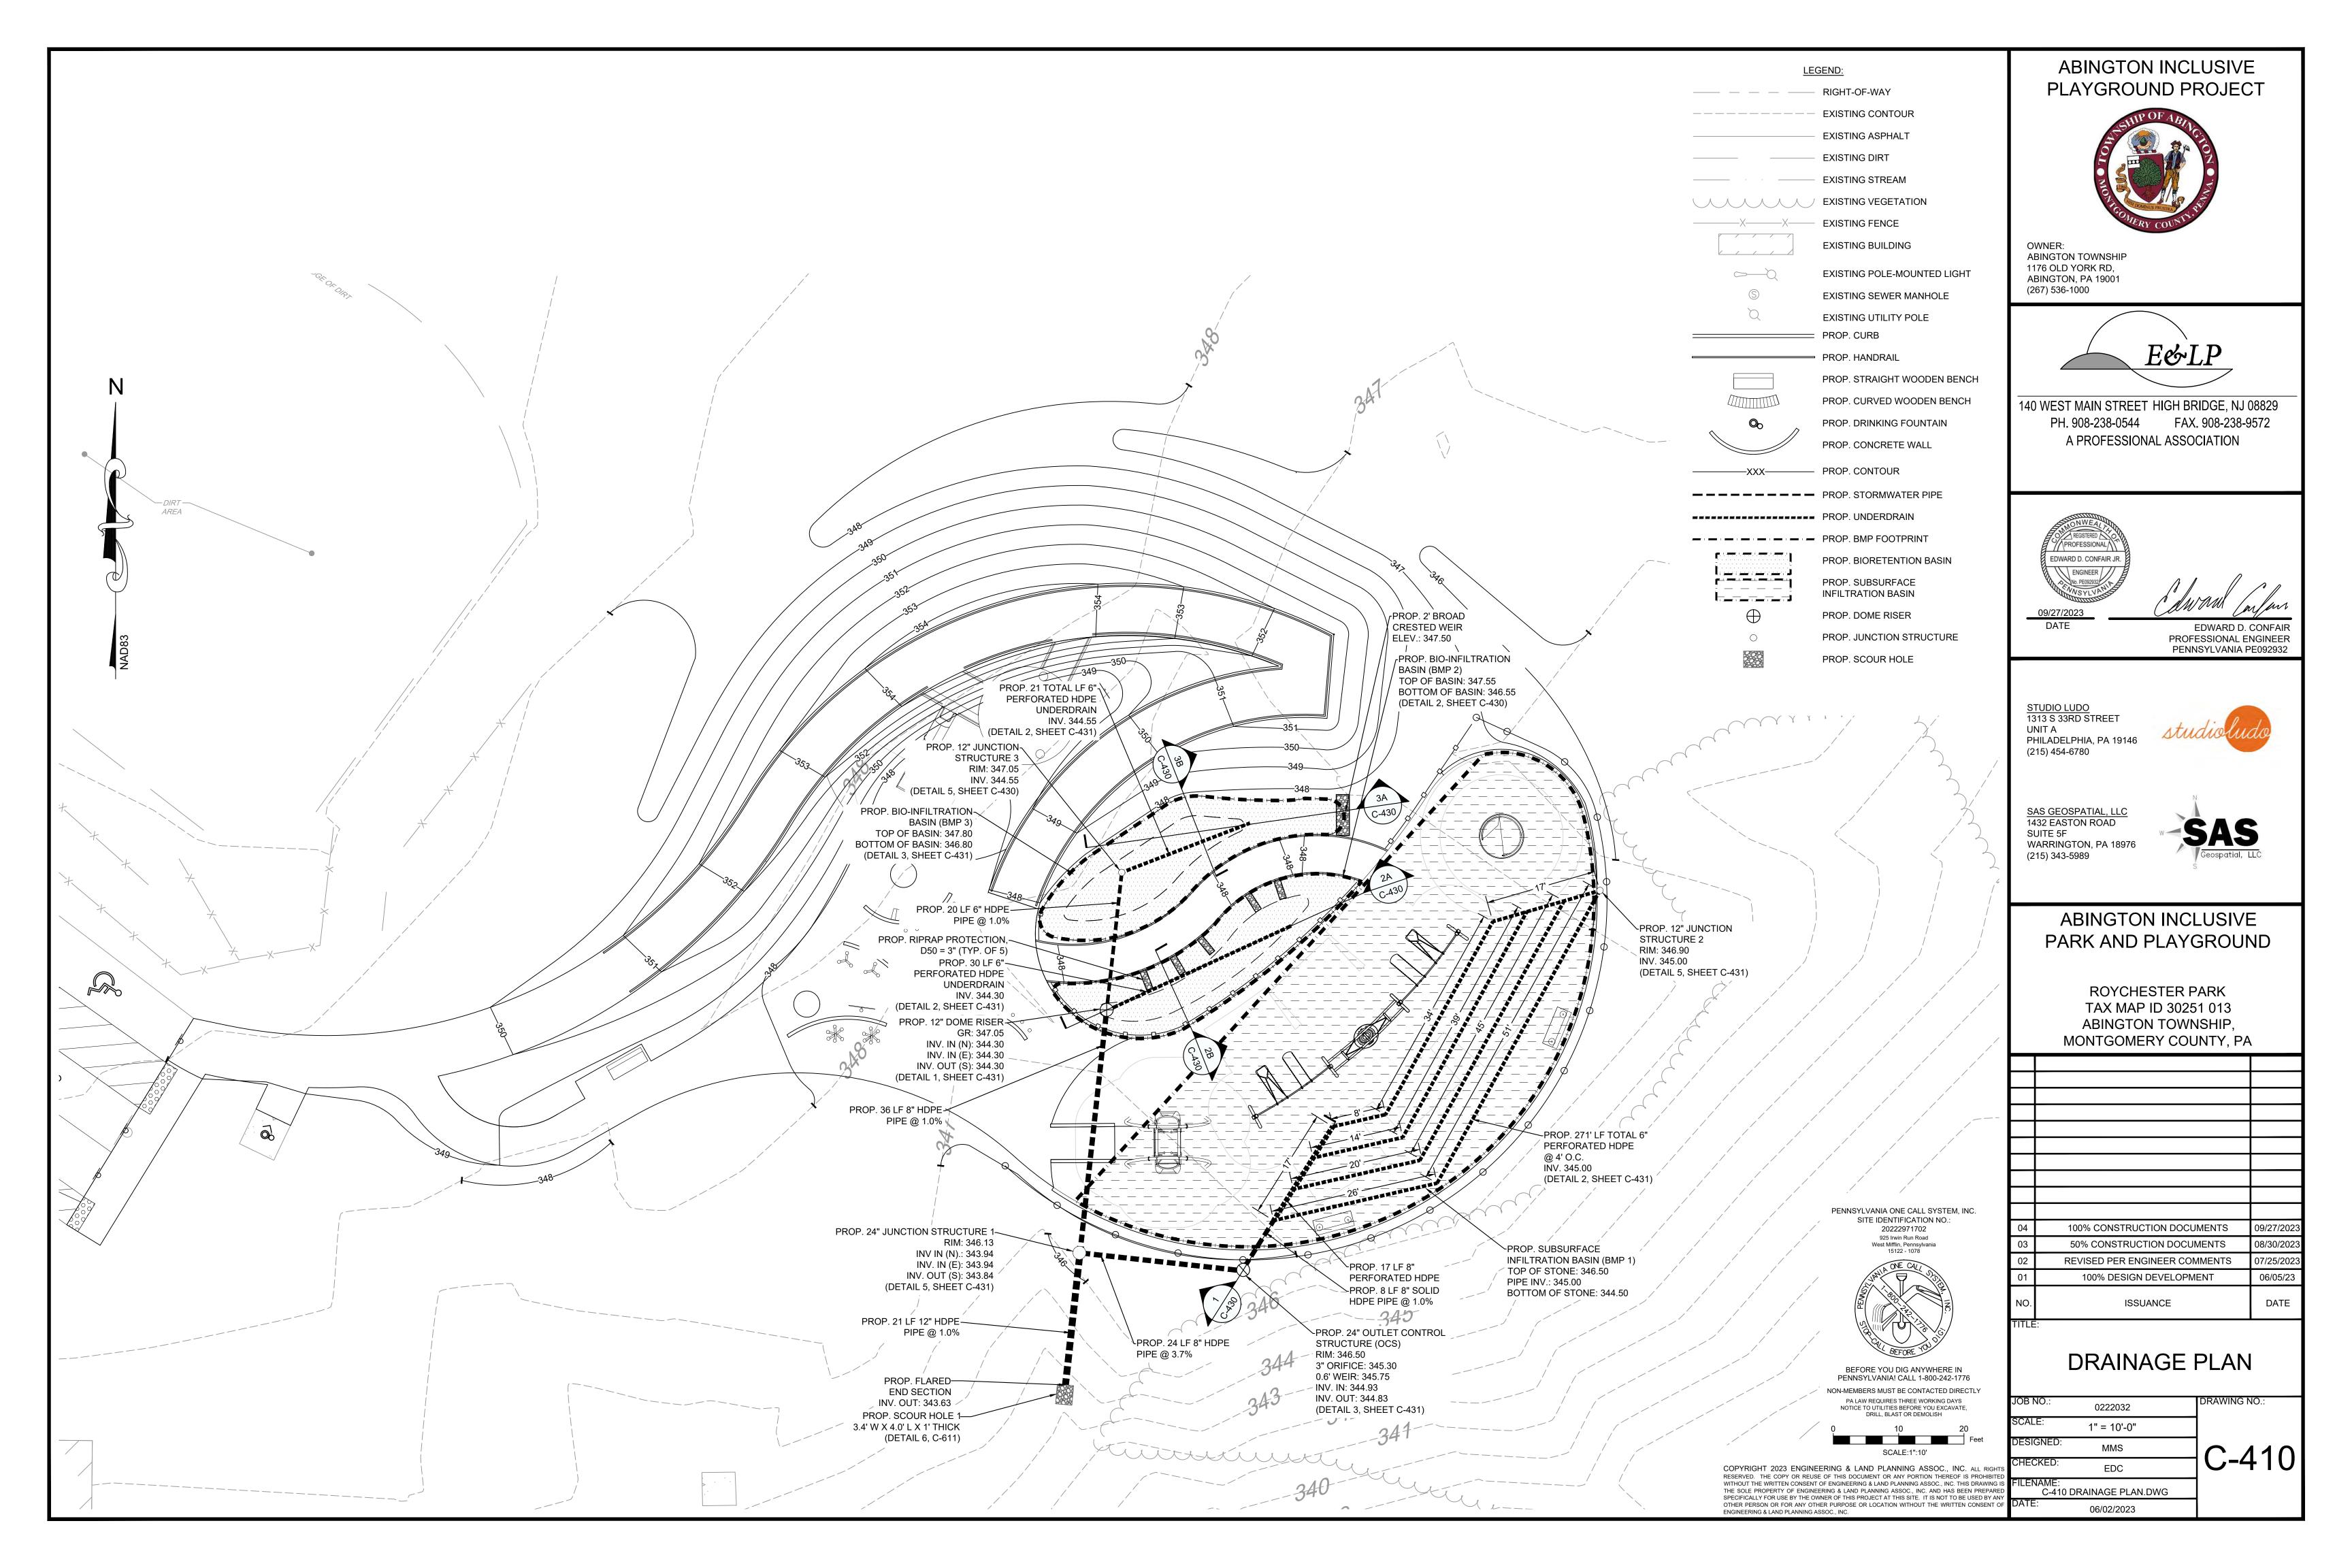

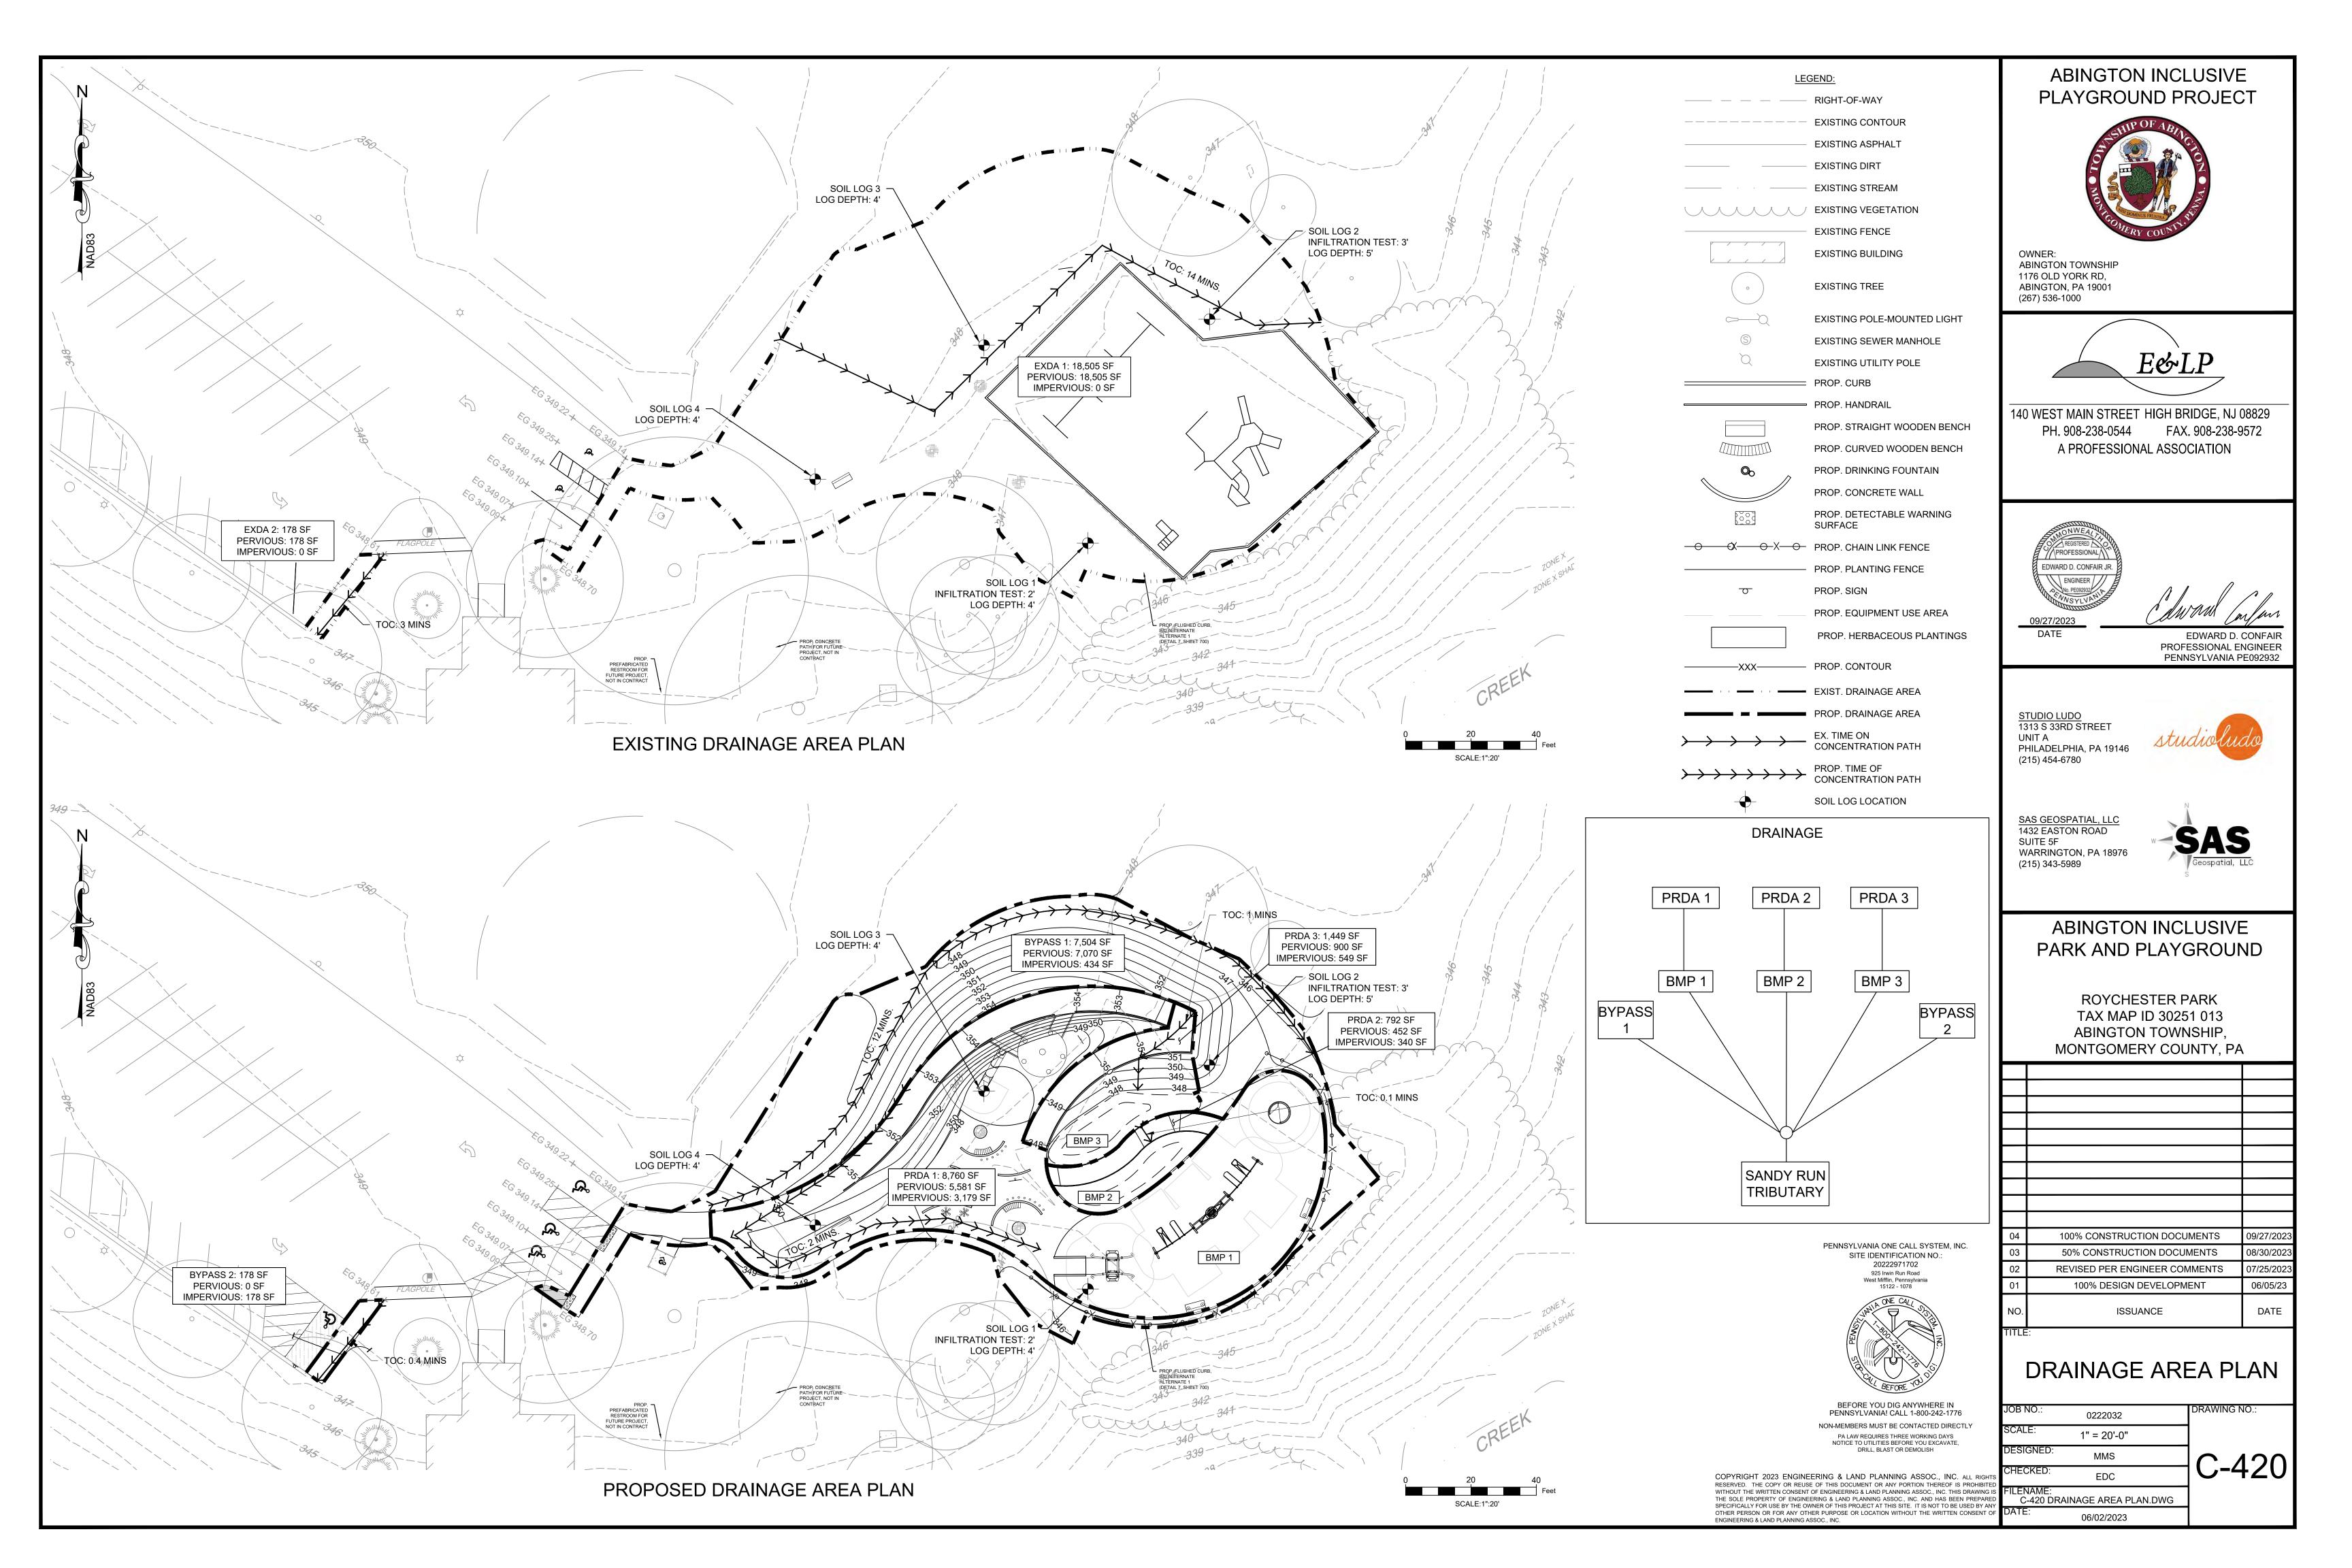


	BOTTOM OF BASIN	TOP OF BASIN	INVERT OUT	RIM	RECTANGULAR WEIR	ORIFICE	WATER QUALITY ELEVATION
	А	В	С	D	E	F	
BMP 1	344.50	346.50	344.83	346.50	345.75	345.30	345.13

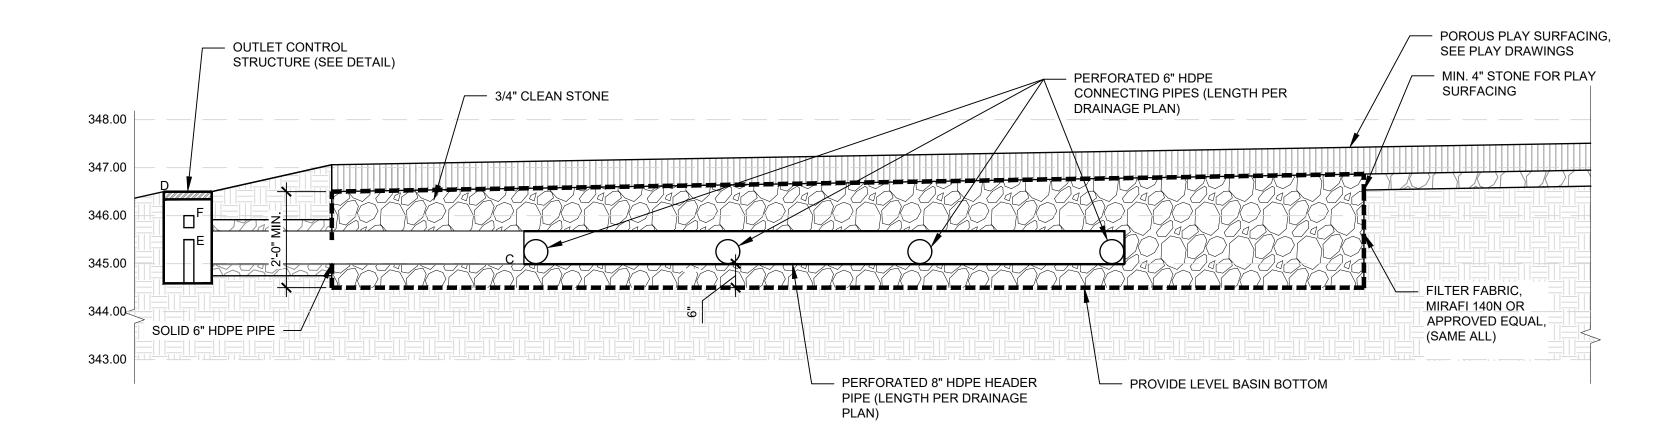

SUBSURFACE INFILTRATION BASIN DETAIL (BMP 1)

BIORETENTION BASIN DETAIL (BMP 3)

1/2"=1'-0"

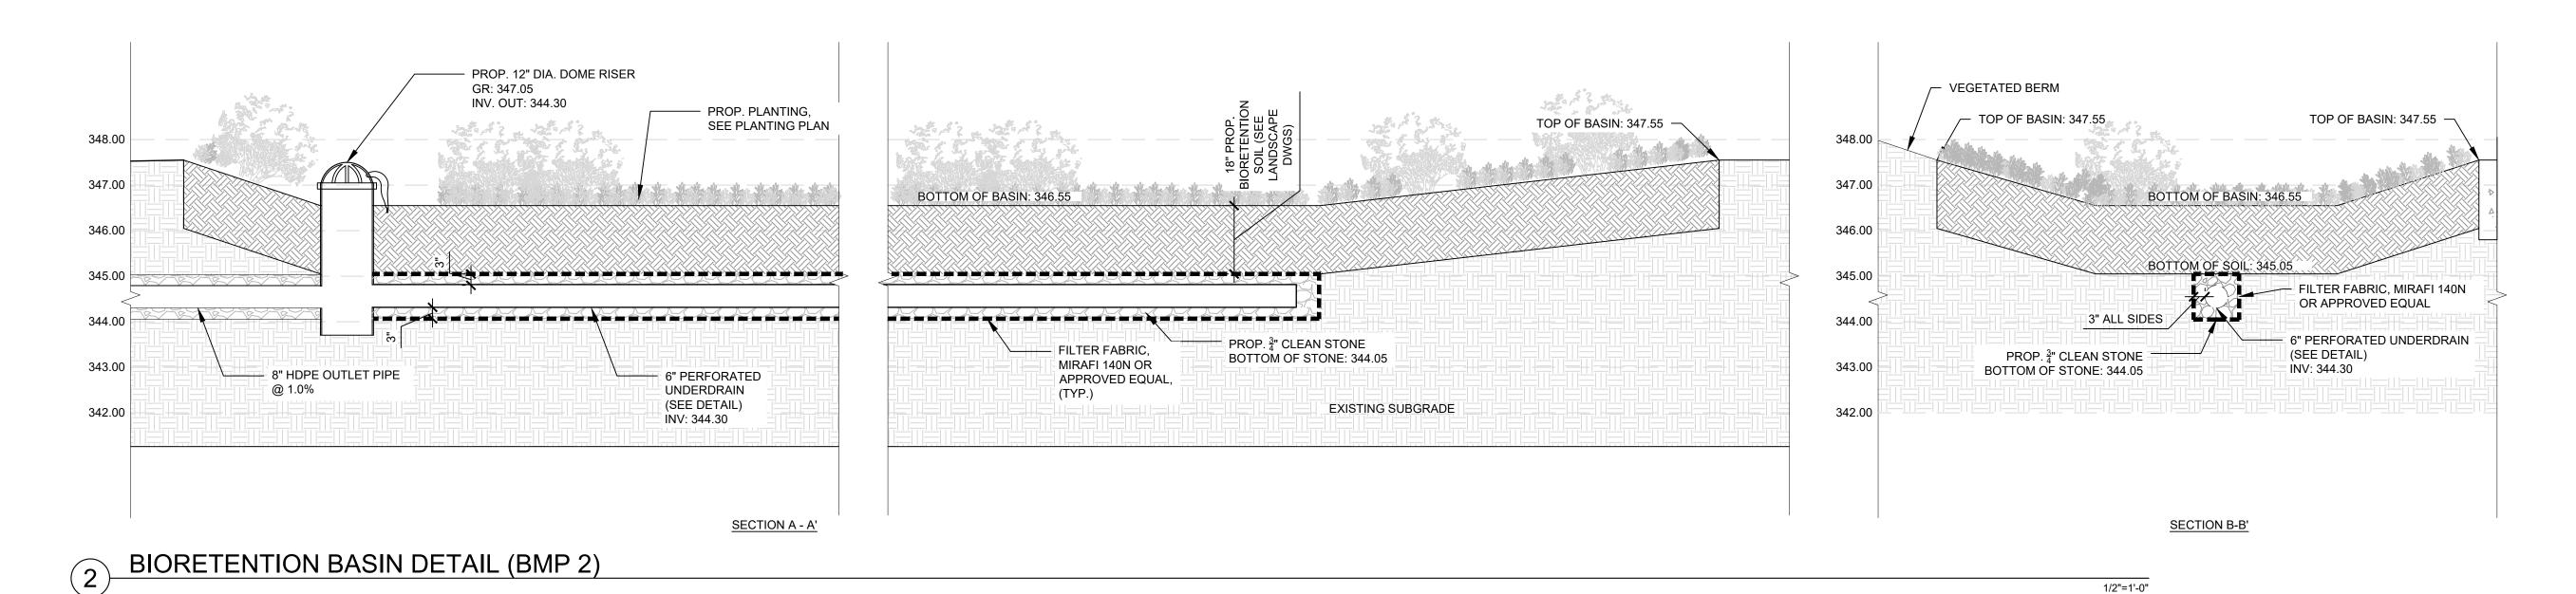


PROP. JUNCTION —— STRUCTURE PROP. PLANTING, SEE -PLANTING PLAN EL. 349.00 PROP. — BROADCRESTED WEIR TOP OF BASIN: 347.80 BIORETENTION ELEV: 347.50 (SEE SOIL EL. 348.00 BOTTOM OF BASIN: 346.80 EL. 347.00 EL. 346.00 EL. 345.00[^] EL. 345.00 FILTER FABRIC, MIRAFI 140N OR APPROVED EQUAL AAAAAAA 3" ALL SIDES UNCOMPACTED SUBGRADE 6" PERFORATED UNDERDRAIN PROP. $\frac{3}{4}$ " CLEAN STONE 6" PERFORATED (SEE DETAIL) BOTTOM OF STONE: 345.65 SEE PLANS FOR SIZE, UNDERDRAIN INV: 344.55 MATERIAL, SLOPE (SEE DETAIL) INV: 344.55 ÎNV: 344.55

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ABINGTON INCLUSIVE PLAYGROUND PROJECT



OWNER: ABINGTON TOWNSHIP 1176 OLD YORK RD, ABINGTON, PA 19001 (267) 536-1000

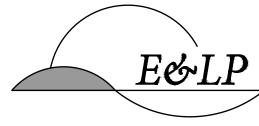

140 WEST MAIN STREET HIGH BRIDGE, NJ 08829 PH. 908-238-0544 FAX. 908-238-9572 A PROFESSIONAL ASSOCIATION



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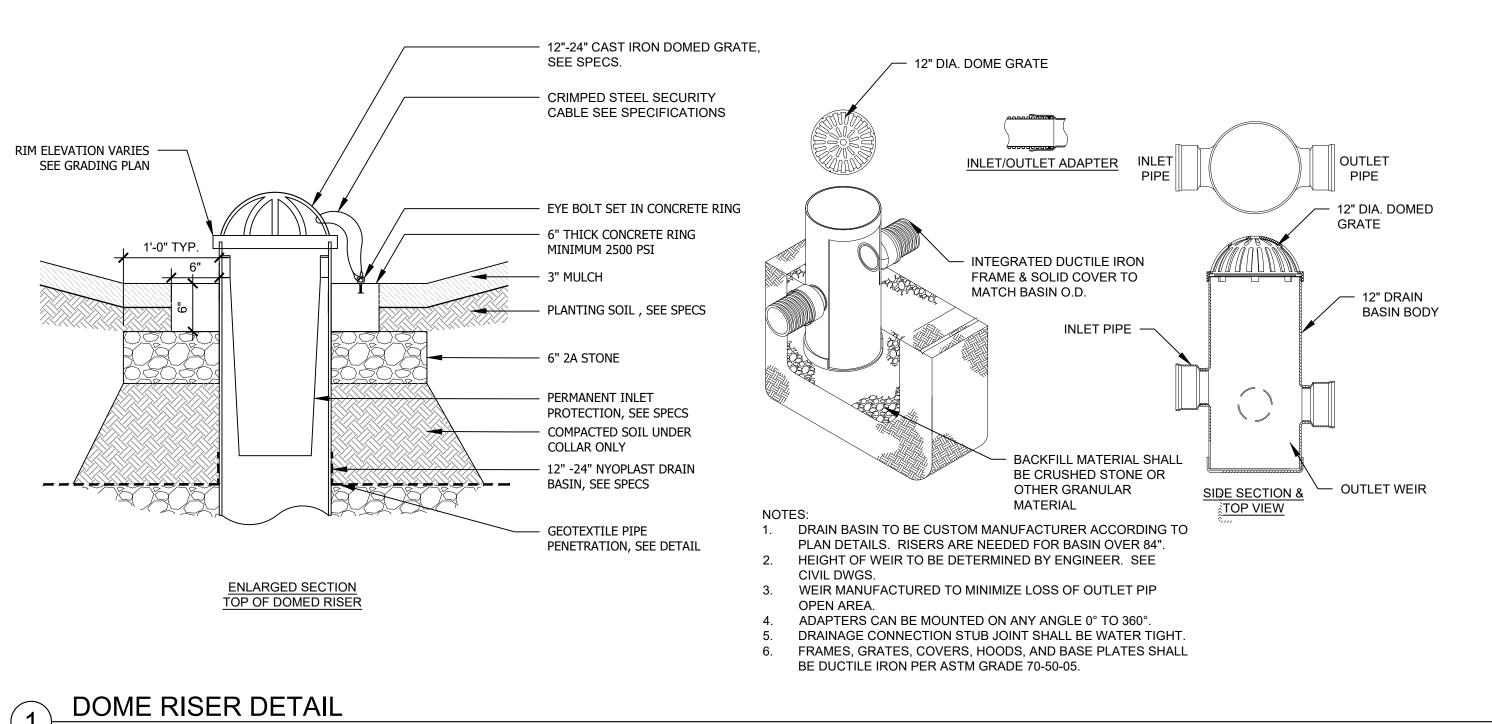
ABINGTON INCLUSIVE PARK AND PLAYGROUND

ROYCHESTER PARK TAX MAP ID 30251 013 ABINGTON TOWNSHIP, MONTGOMERY COUNTY, PA

4	100% CONSTRUCTION DOCUMENTS	09/27/202
3	50% CONSTRUCTION DOCUMENTS	08/30/202
2	REVISED PER ENGINEER COMMENTS	07/25/202
1	100% DESIGN DEVELOPMENT	06/05/23
Ο.	ISSUANCE	DATE
LE	:	

DRAINAGE DETAILS

OB NO.:	0222032	DRAWING NO.:
SCALE:	AS SHOWN	
ESIGNED:	MMS	\Box \frown 13
CHECKED:	EDC	 し-4 く
ILENAME: C-430 DF	RAINAGE DETAILS.DWG	
ATE:	06/02/2023	




TOP OF BERM

2'-0"

CROSS-SECTION

STONE WEIR DETAIL


BROADCRESTED WEIR ELEV. (SEE PLANS)

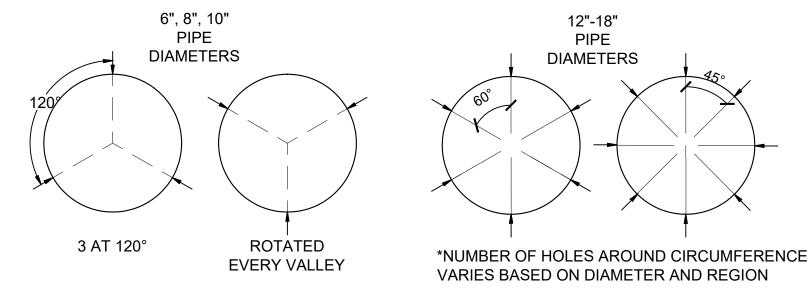

NOTES:

1. ACTUAL PATTERN MAY VARY BY REGION, HOWEVER ALL PATTERNS MEET THE AASHTO AND ASTM MINIMUM REQUIREMENTS FOR THE OPEN INLET AREA

AASHTO CLASS II PERFORATION						
NOMINAL I.D. (INCHES)	PERFORATION TYPE	MAXIMUM SLOT LENGTH (INCHES)	MAXIMUM SLOT WIDTH (INCHES)	MINIMUM INLET AREA (IN ² /FT)		
6	SLOT	0.875	0.125	1.0		
8	SLOT	1.18	0.125	1.0		
10	SLOT	1.18	0.125	1.0		
12	CIRCULAR	0.313	-	1.5		

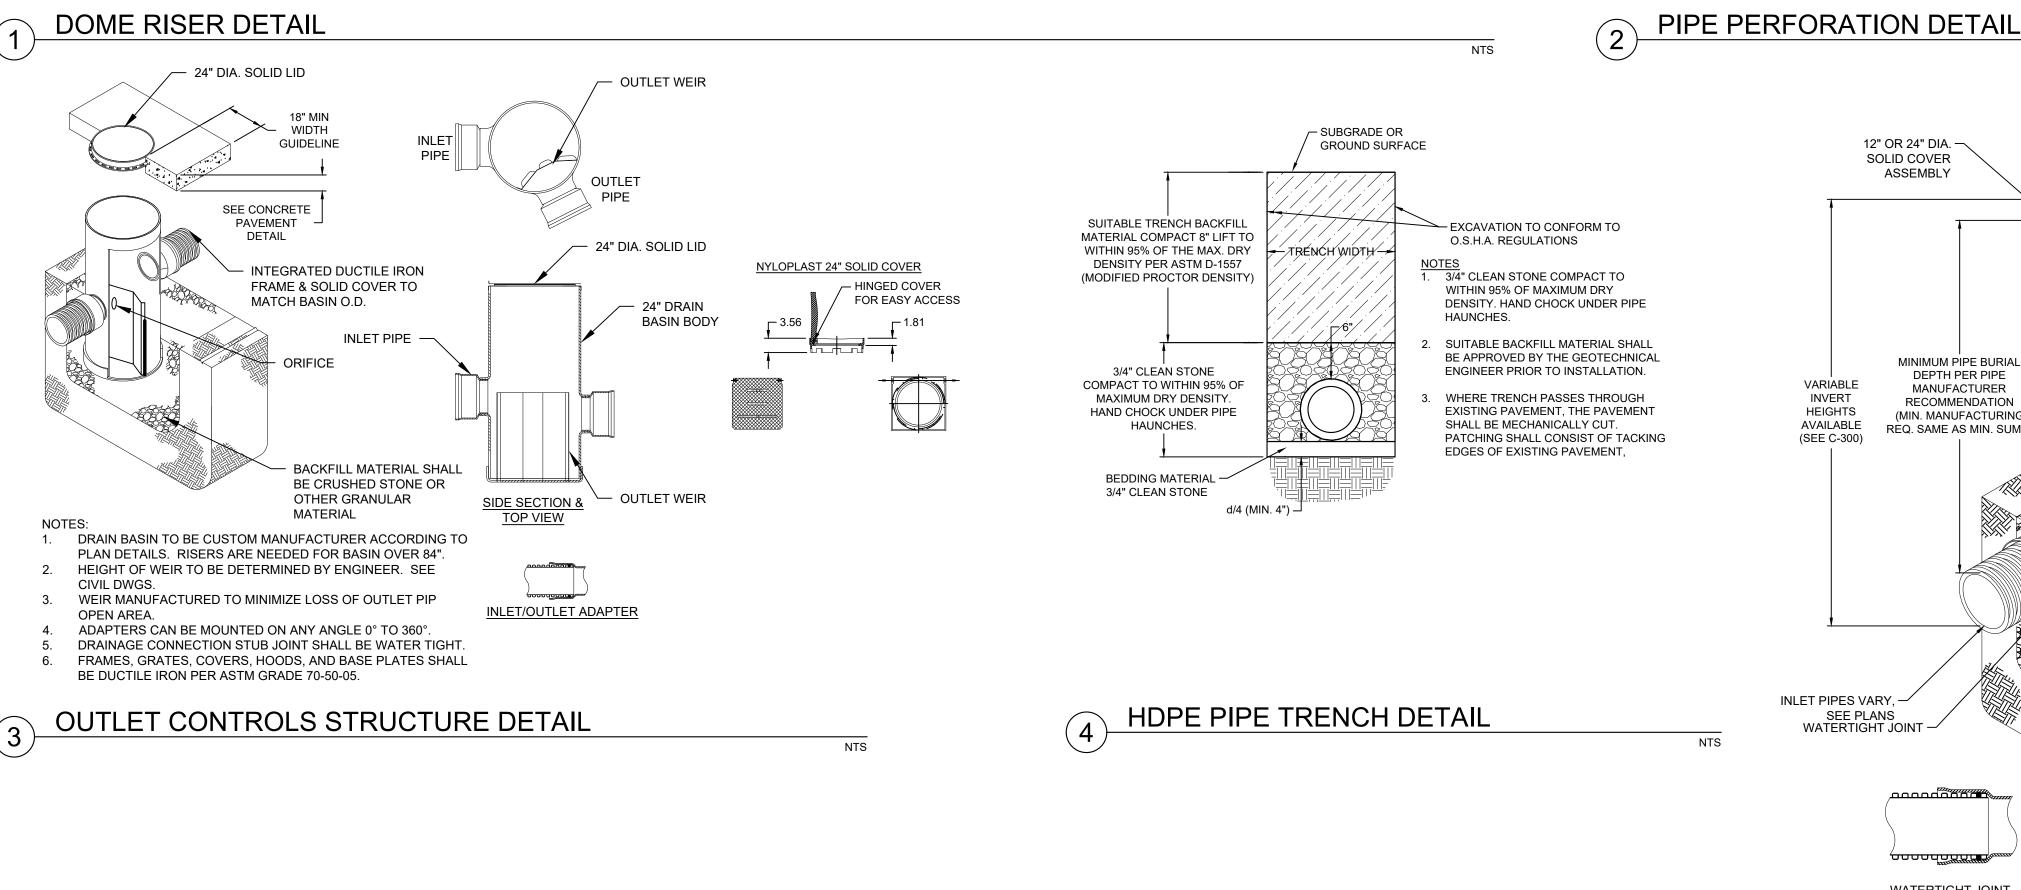

FINISHED GRADE,

SEE SPECS.

SUBGRADE


SEE GRADING PLAN

PROPOSED BURIED GABION

PROPOSED BIOFILTRATION SOILS,

WALL AT BROADCRESTED


- EXISTING UNCOMPACTED

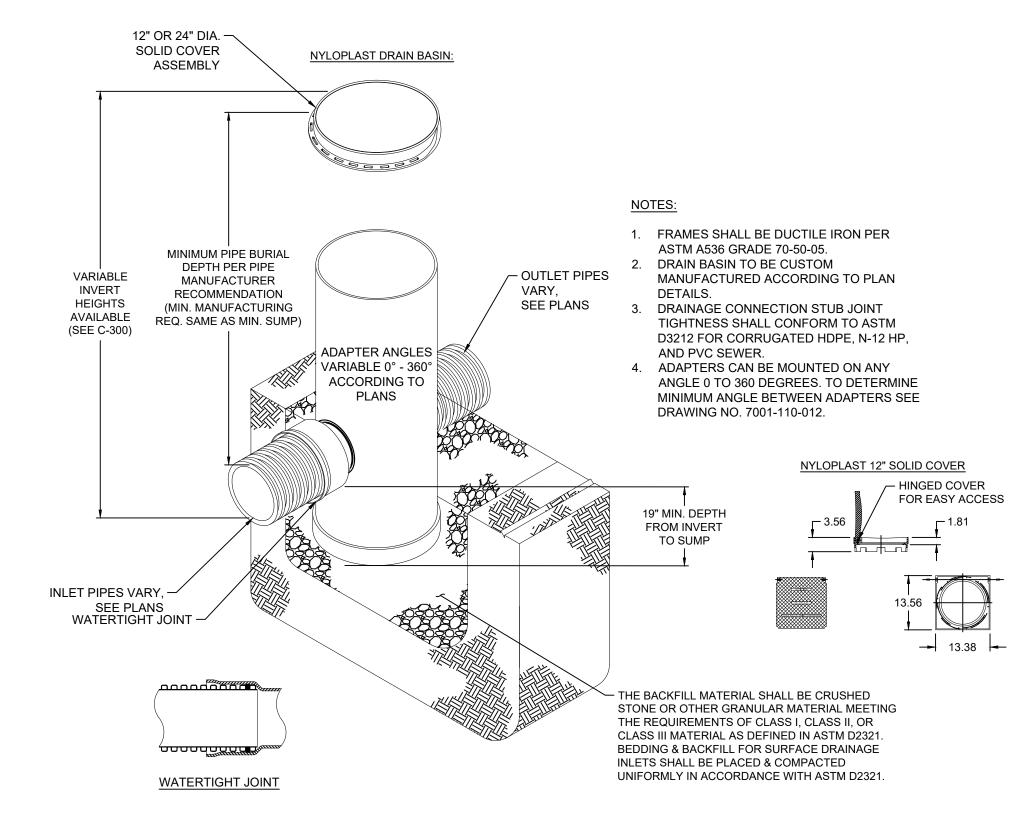

NTS

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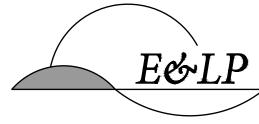
NTS

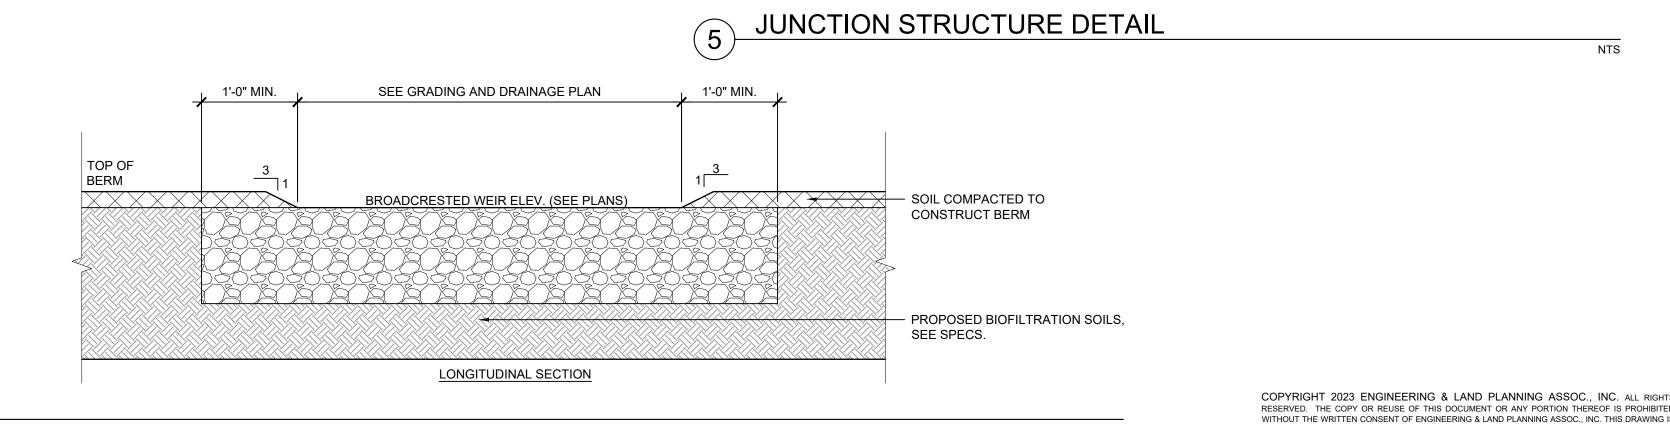

ABINGTON INCLUSIVE PLAYGROUND PROJECT



OWNER: ABINGTON TOWNSHIP 1176 OLD YORK RD, ABINGTON, PA 19001 (267) 536-1000



140 WEST MAIN STREET HIGH BRIDGE, NJ 08829 FAX. 908-238-9572 PH. 908-238-0544 A PROFESSIONAL ASSOCIATION



09/27/2023

DATE

EDWARD D. CONFAIR

PROFESSIONAL ENGINEER PENNSYLVANIA PE092932

STUDIO LUDO 1313 S 33RD STREET UNIT A PHILADELPHIA, PA 19146 (215) 454-6780



SAS GEOSPATIAL, LLC 1432 EASTON ROAD SUITE 5F WARRINGTON, PA 18976 (215) 343-5989



ABINGTON INCLUSIVE PARK AND PLAYGROUND

ROYCHESTER PARK TAX MAP ID 30251 013 ABINGTON TOWNSHIP, MONTGOMERY COUNTY, PA

04	100% CONSTRUCTION DOCUMENTS	09/27/2023
03	50% CONSTRUCTION DOCUMENTS	08/30/2023
02	REVISED PER ENGINEER COMMENTS	07/25/2023
01	100% DESIGN DEVELOPMENT	06/05/23
NO.	ISSUANCE	DATE
TITLE	:	

DRAINAGE DETAILS

110			DD AMAINIO NIO
NO.:	0222032		DRAWING NO.:
LE:	AS SHOWN		
SIGNED:	MMS		C 121
CKED:	EDC		U-43 I
NAME: C-430 DI	RAINAGE DETAILS.DWG	3	
E:	06/02/2023		

BASE BID PLANT SCH						1
TREES	QTY	BOTANICAL NAME	COMMON NAME	SIZE	SPACING	REMARKS
BeNi	6	Betula Nigra	River Birch	1.5" - 2" Cal.	PER PLAN	В+В
MaVi	3	Magnolia Virginiana	Sweetbay Magnolia	1.5" - 2" Cal.	PER PLAN	В+В
CeCa	4	Cercis Canadensis	Eastern Redbud	1.5" - 2" Cal.	PER PLAN	В+В
SHRUBS			·			
CIAI	3	Clethra alnifolia 'Pink Spire'	Summersweet Clethra	3 Gal	PER PLAN	Cont
HyAr	9	Hydrangea arborescens 'Annabelle'	Smooth Hydrangea	3 Gal	PER PLAN	Cont
PERENNIALS/GRASS	ES		·		•	
	197	Carex Vullpinoidea	Brown Fox Sedge	PLUG, 2.25" DEEP, 1.52" WIDTH MIN.	18" o.c.	Basis of Design for landscape plugs:
Diaratantian Mix	74	Iris Veriscolor	Northern Blue Flag	PLUG, 2.25" DEEP, 1.52" WIDTH MIN.	18" o.c.	Northcreek nursery 388 N Creek Rd Landenberg, PA 19350
Bioretention Mix	148	Carex Grayi	Gray Sedge	PLUG, 2.25" DEEP, 1.52" WIDTH MIN.	18" o.c.	HTTPS://WWW.NORTHCREEKNURSERIES.COM Tel.: (610) 255-0100
	74	Heliopsis Helianthoides	Early Sunflower	PLUG, 2.25" DEEP, 1.52" WIDTH MIN.	18" o.c.	1

PROP. LAWN SEEDING

RESTORED, SEE SESC PLAN FOR EXTENT

PROP. SOD ON BERM,

SEE SPECIFICATIONS

IN ALL DISTURBED AREAS TO BE BE

BASIS FOR DESIGN: RETENTION BASIN WILDLIFE MIX ITEM NUMBER: ERNMX-127 ERNST SEEDS 8884 MERCER PIKE MEADVILLE, PA 16335 TEL: (800) 873-3321

SALES@ERNSTSEED.COM

30.0% PANICUM CLANDESTINUM, TIOGA (DEERTONGUE, TIOGA)

29.5% CAREX VULPINOIDEA, PA ECOTYPE (FOX SEDGE, PA ECOTYPE)

20.0% ELYMUS VIRGINICUS, MADISON-NY ECOTYPE (VIRGINIA WILDRYE, MADISON-NY ECOTYPE) 7.0% CAREX LURIDA, PA ECOTYPE (LURID SEDGE, PA ECOTYPE)

7.0% CAREX SCOPARIA, PA ECOTYPE (BLUNT BROOM SEDGE, PA ECOTYPE) 3.0% VERBENA HASTATA, PA ECOTYPE (BLUE VERVAIN, PA ECOTYPE)

1.5% JUNCUS EFFUSUS (SOFT RUSH)

0.5% AGROSTIS PERENNANS, ALBANY PINE BUSH-NY ECOTYPE (AUTUMN BENTGRASS, ALBANY PINE BUSH-NY ECOTYPE)

UNDERSTORY

TREE (TYP.)

(DETAIL 1

SHEET C- 702) CeCa

0.5% ASCLEPIAS INCARNATA, PA ECOTYPE (SWAMP MILKWEED, PA ECOTYPE) 0.2% HELENIUM AUTUMNALE, PA ECOTYPE (COMMON SNEEZEWEED, PA ECOTYPE)

0.2% SCIRPUS CYPERINUS, PA ECOTYPE (WOOLGRASS, PA ECOTYPE)

0.1% ASTER LANCEOLATUS (LANCE LEAVED ASTER)

AREA

0.1% ASTER NOVAE-ANGLIAE, PA ECOTYPE (NEW ENGLAND ASTER, PA ECOTYPE) 0.1% ASTER PUNICEUS, PA ECOTYPE (PURPLESTEM ASTER, PA ECOTYPE)

0.1% LOBELIA SIPHILITICA, PA ECOTYPE (GREAT BLUE LOBELIA, PA ECOTYPE)


0.1% MIMULUS RINGENS, PA ECOTYPE (SQUARE STEMMED MONKEYFLOWER, PA ECOTYPE)

0.1% SCIRPUS ATROVIRENS, PA ECOTYPE (GREEN BULRUSH, PA ECOTYPE)

LANDSCAPE NOTES:

PROP. RELOCATED

- 1. ALL PLANT MATERIALS SHALL BE OF NURSERY STOCK AND SHALL BE OF SYMMETRICAL GROWTH, FREE OF INSECTS, PESTS AND DISEASE. THE OWNER OR HIS REPRESENTATIVE RESERVES THE RIGHT TO INSPECT AND APPROVE ALL PLANT MATERIALS AND REJECT ANY PLANTS FOUND TO BE UNACCEPTABLE.
- 2. COORDINATE ALL TREE LOCATIONS WITH STRUCTURAL SLAB DESIGN AND DRAINAGE
- 3. DAMAGE TO EXISTING OR NEW WORK BY CONTRACTOR SHALL BE REPAIRED AT HIS EXPENSE. 4. CONTRACTOR SHALL FAMILIARIZE HIMSELF WITH ALL UTILITIES AND NOTIFY LANDSCAPE
- ARCHITECT OF ANY DISCREPANCIES OR CONFLICTS PRIOR TO CONSTRUCTION.
- 5. CONTRACTOR SHALL VERIFY PLANT LIST QUANTITIES INDICATED ON PLANS AND NOTIFY LANDSCAPE ARCHITECT OF ANY DISCREPANCIES IN QUANTITIES PRIOR TO CONSTRUCTION. 6. THE CONTRACTOR SHALL TAKE ALL PRECAUTIONS NECESSARY WITH REGARDS TO THE
- CARTING, STORING AND PLANTING OF MATERIALS TO PROTECT ADJACENT FINISHED WORK. 7. PLANT MATERIALS SHALL BE MAINTAINED BEFORE, DURING AND AFTER IN THE BEST HORTICULTURAL CONDITION. CONTRACTOR SHALL PRUNE ALL DEAD OR DISEASED LIMBS, BRANCHES AND CANES FROM EXISTING DECIDUOUS AND CONIFEROUS TREES. METHODS SHALL REFLECT BEST HORTICULTURAL PRACTICES AS OUTLINED IN THE AMERICAN
- NURSERYMEN ASSOCIATION CERTIFICATION AND STANDARDS LATEST EDITION. 8. THE CONTRACTOR SHALL ENSURE THAT ALL PLANT MATERIALS SHALL ARRIVE AT THE SITE
- WITH ROOT BALL AND BURLAP INTACT. 9. THE CONTRACTOR SHALL REMOVE ALL DEAD AND BROKEN CANES AND BRANCHES.
- 10. ALL PLANTING SOIL SHALL BE PER SPECIFICATIONS.
- 11. THE CONTRACTOR SHALL INSTALL ALL PLANT MATERIALS PER THE PLANTING DETAILS AND SPECIFICATIONS.
- 12. THE CONTRACTOR SHALL REPLACE ANY PLANT MATERIALS WITHIN ONE GROWING SEASON FOR PLANT MATERIALS THAT ARE NO LONGER VIABLE.
- 13. ALL PLANT MATERIAL SHALL CONFORM TO THE HORTICULTURAL STANDARDS AS SET FORTH BY THE AMERICAN NURSERYMEN AND LANDSCAPING ASSOCIATION (ANLA 2000). CONTRACTOR SHALL REMOVE ALL NON-BIODEGRADABLE ROOT WRAPPING PRIOR TO PLANTING.

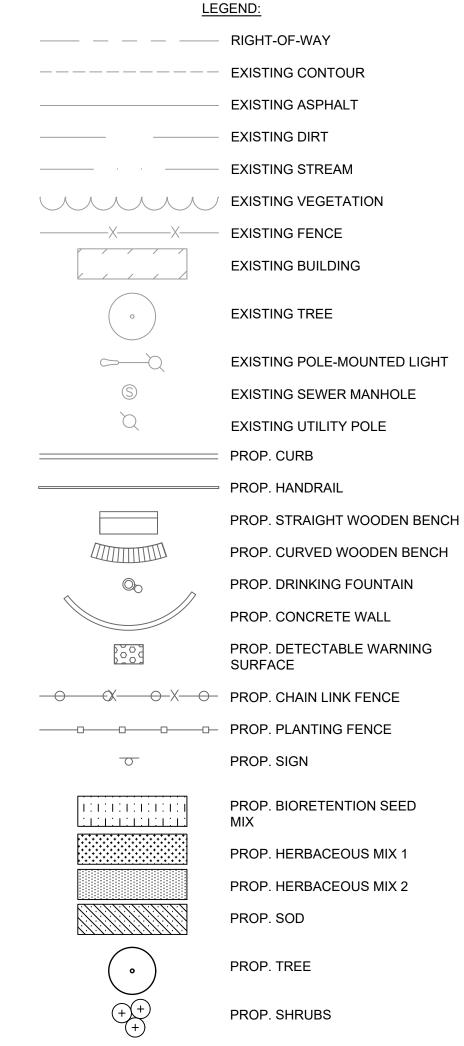

1313 S 33RD STREET UNIT A PHILADELPHIA, PA 19146 (215) 454-6780

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OWNER:

ABINGTON TOWNSHIP

EDWARD D. CONFAIR JR.

09/27/2023

DATE

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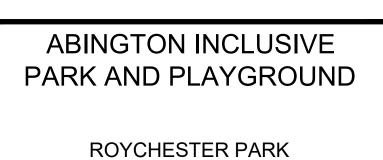
ABINGTON, PA 19001

(267) 536-1000



EDWARD D. CONFAIR PROFESSIONAL ENGINEER

PENNSYLVANIA PE092932



TAX MAP ID 30251 013

ABINGTON INCLUSIVE

PLAYGROUND PROJECT

E&LP

140 WEST MAIN STREET HIGH BRIDGE, NJ 08829

A PROFESSIONAL ASSOCIATION


PH. 908-238-0544 FAX. 908-238-9572


ABINGTON TOWNSHIP, MONTGOMERY COUNTY, PA

100% CONSTRUCTION DOCUMENTS 50% CONSTRUCTION DOCUMENTS REVISED PER ENGINEER COMMENTS 100% DESIGN DEVELOPMENT DATE **ISSUANCE**

PLANTING PLAN

0222032 1" = 10' MMS CHECKED: C-500 PLANTING PLAN 06/02/2023

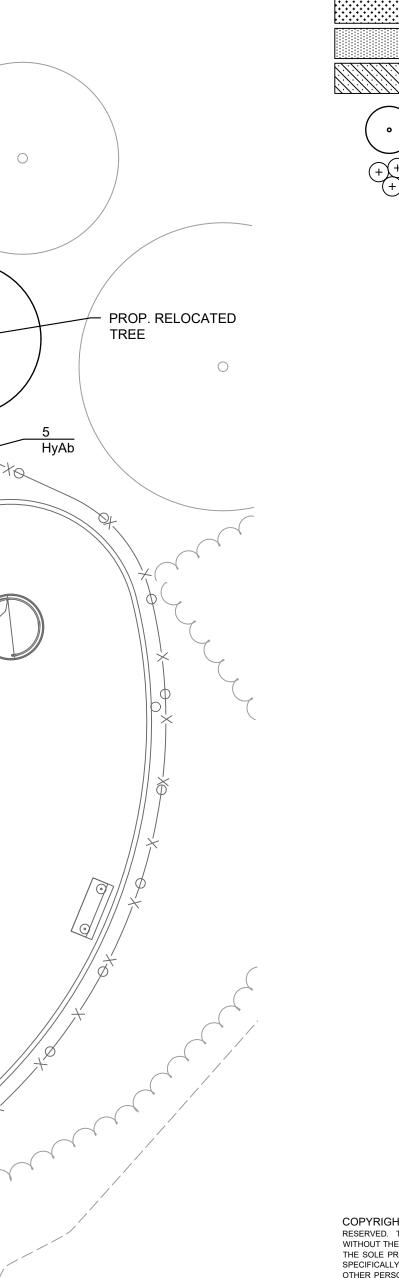

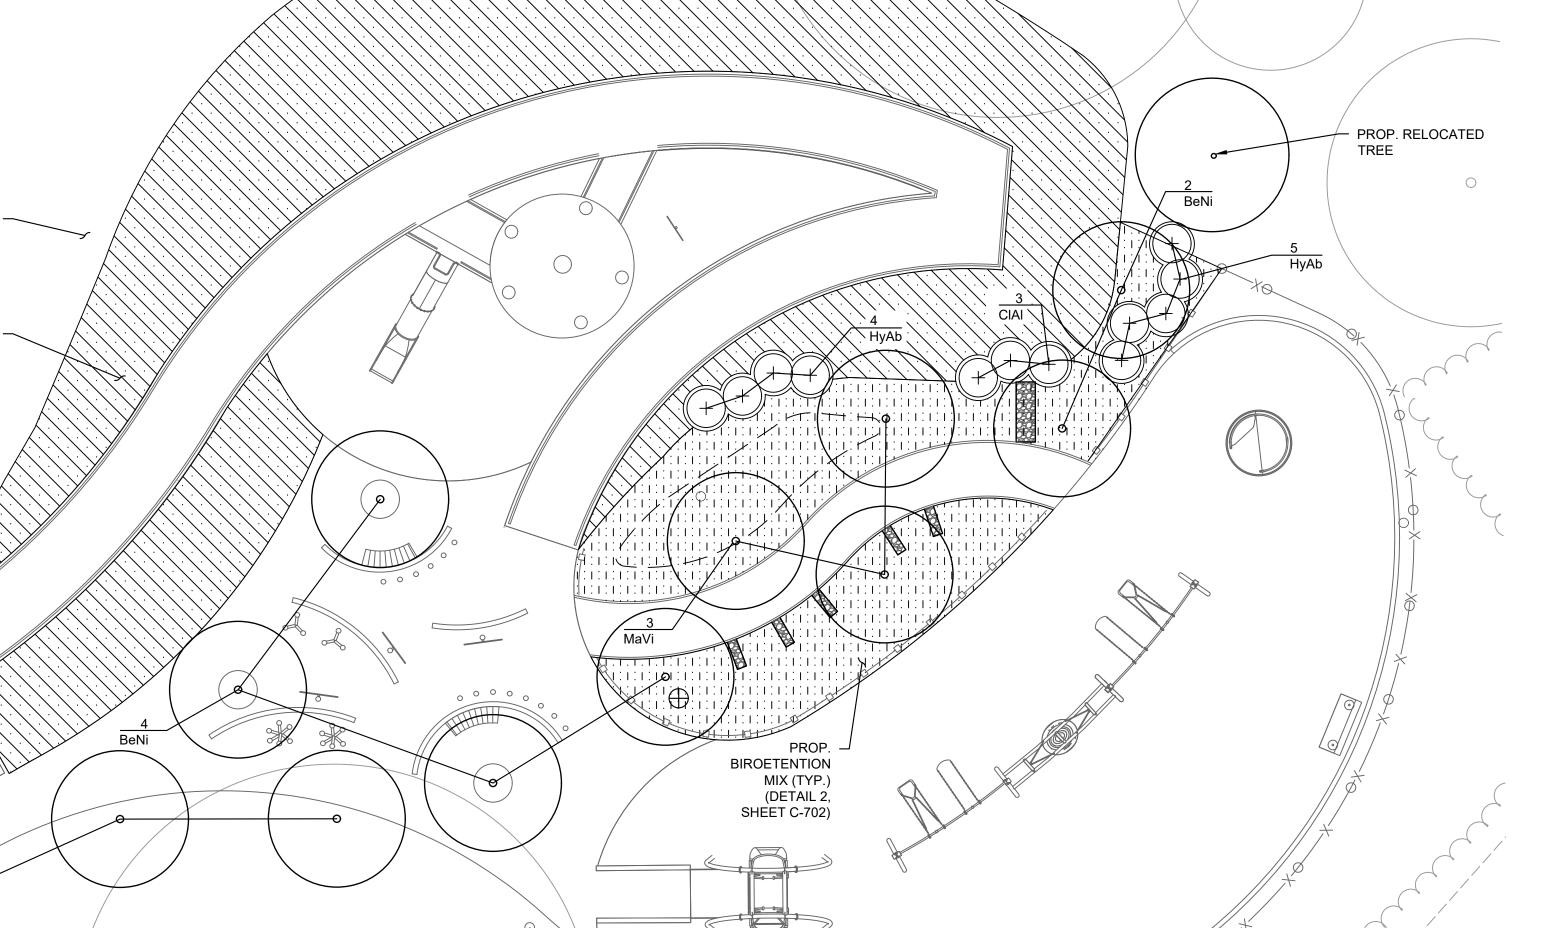






BEFORE YOU DIG ANYWHERE IN PENNSYLVANIA! CALL 1-800-242-1776 NON-MEMBERS MUST BE CONTACTED DIRECTLY PA LAW REQUIRES THREE WORKING DAYS NOTICE TO UTILITIES BEFORE YOU EXCAVATE, DRILL, BLAST OR DEMOLISH

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MONTGOMERY COUNTY CONSERVATION DISTRICT SOIL EROSION & SEDIMENT CONTROL NOTES

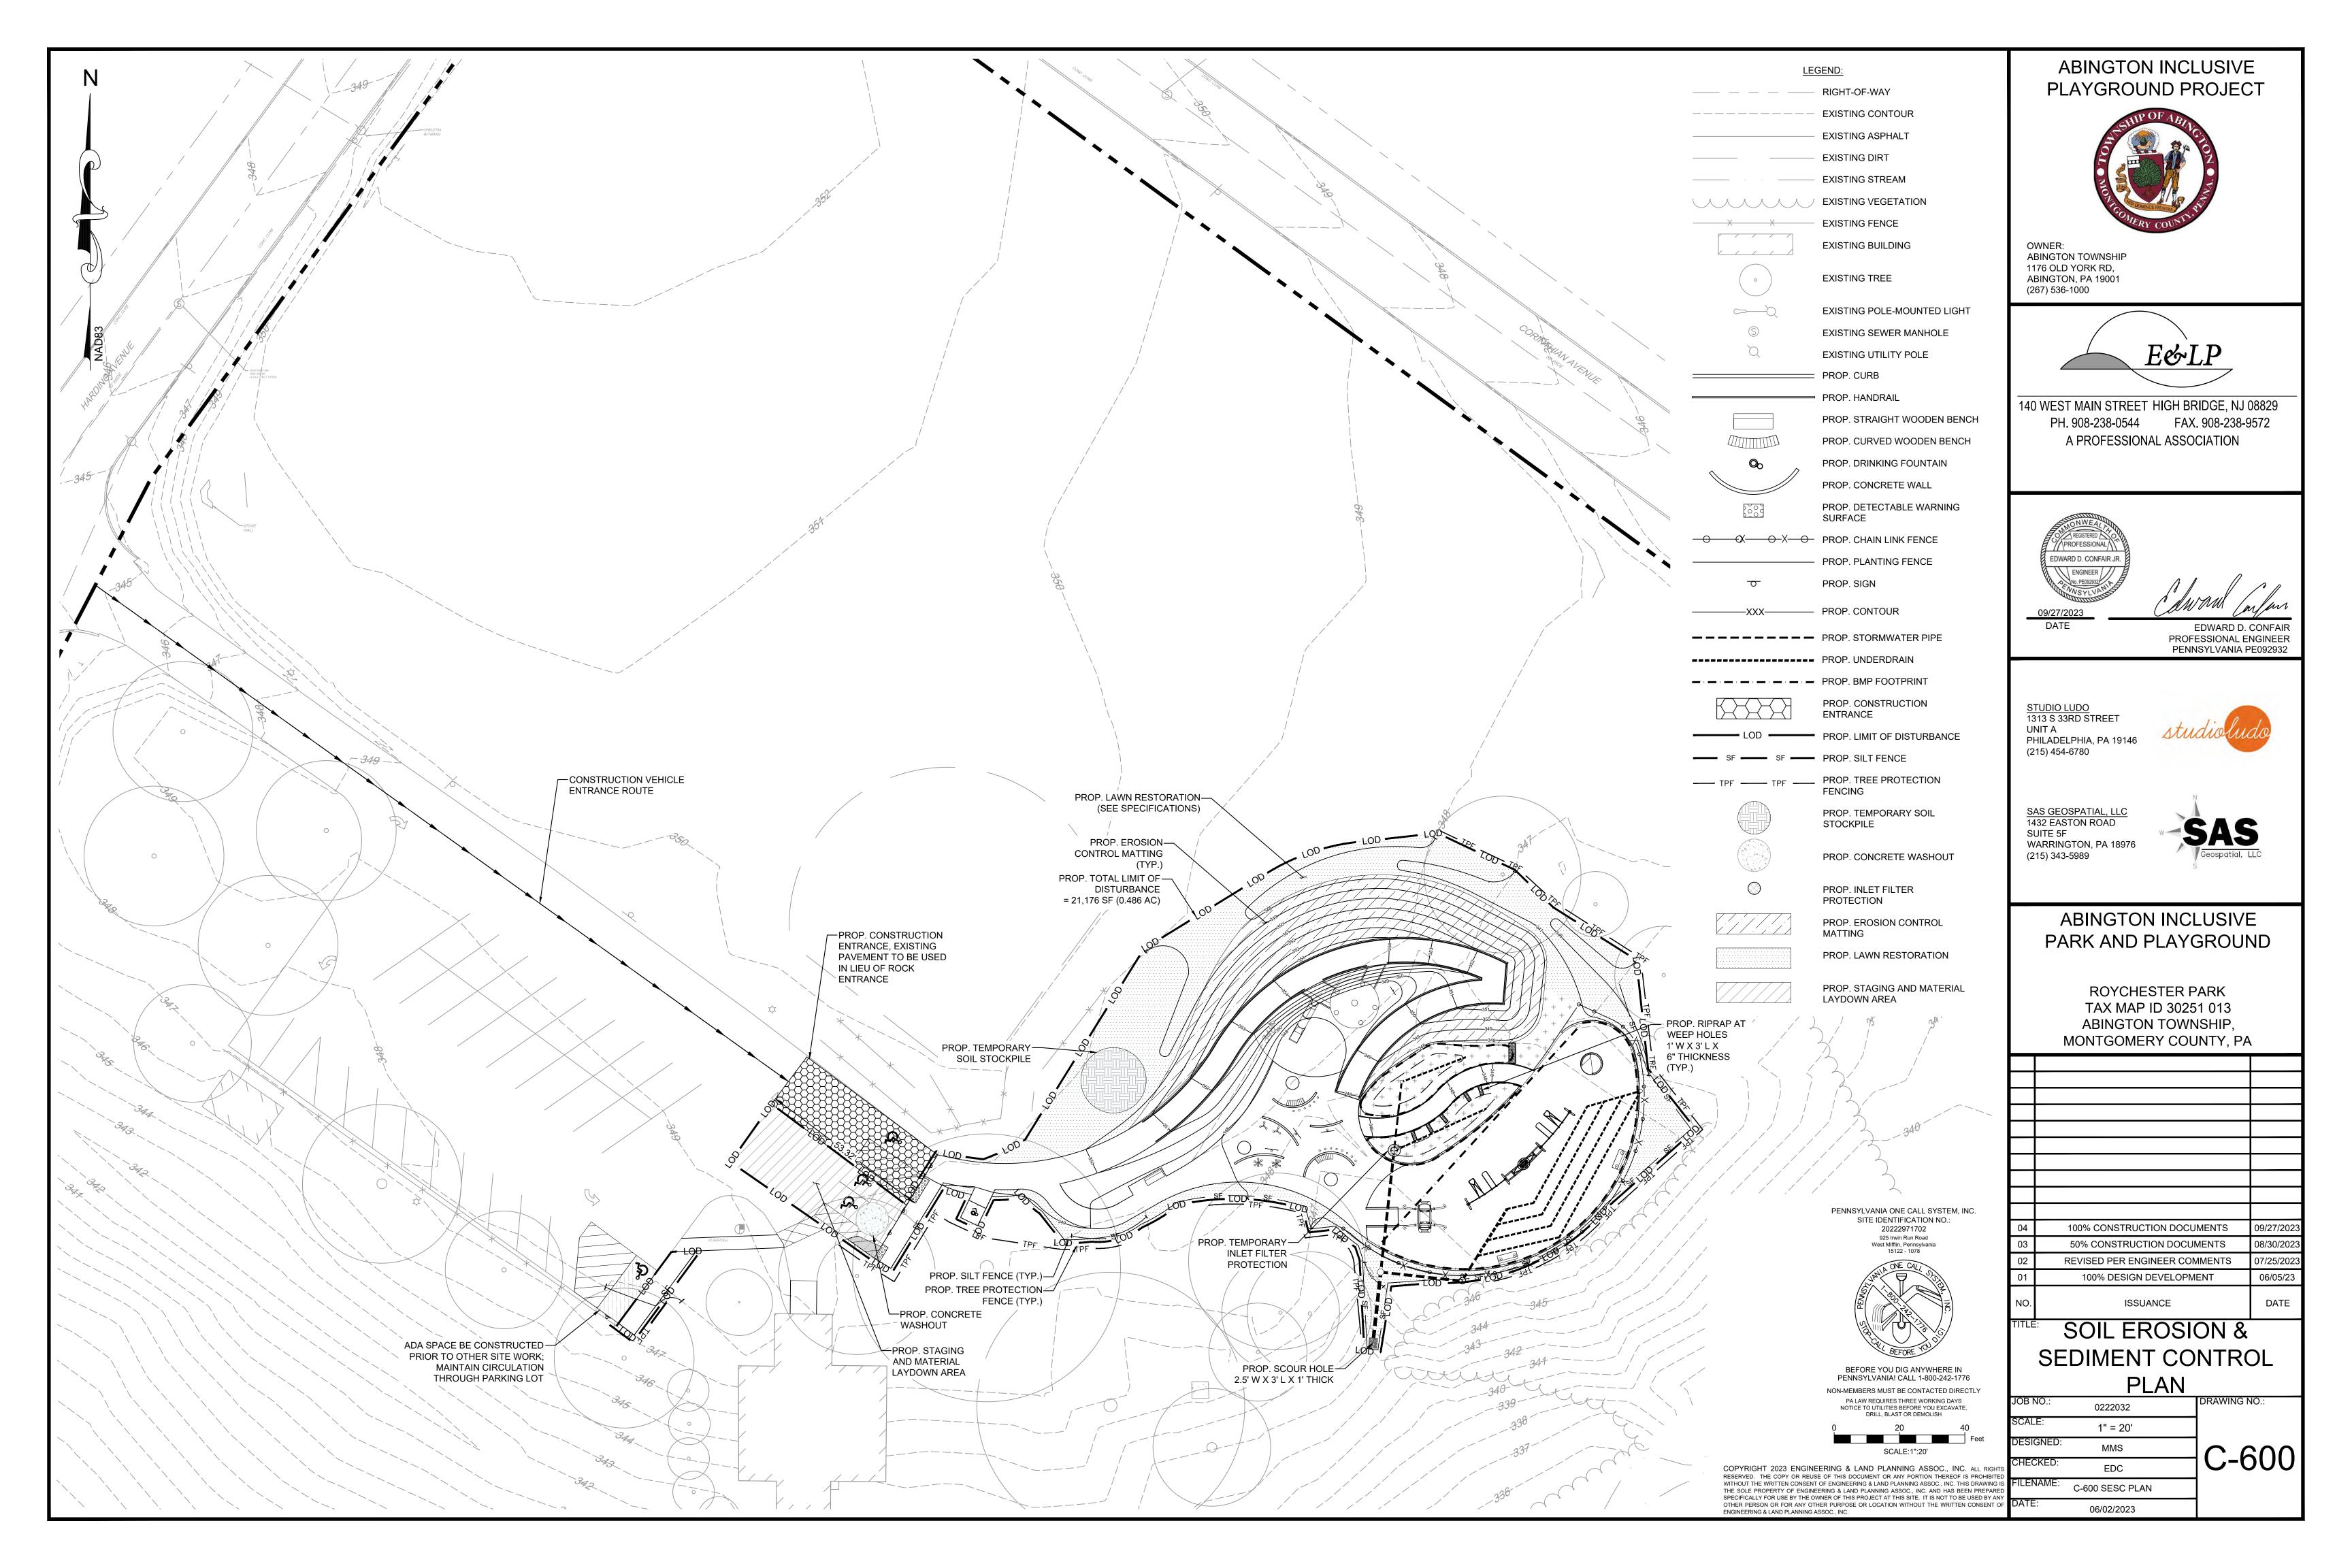- 1. ALL EARTH DISTURBANCES, INCLUDING CLEARING AND GRUBBING AS WELL AS CUTS AND FILLS SHALL BE DONE IN ACCORDANCE WITH THE APPROVED E&S PLAN. A COPY OF THE APPROVED DRAWINGS (STAMPED, SIGNED AND DATED BY THE REVIEWING AGENCY) MUST BE AVAILABLE AT THE PROJECT SITE AT ALL TIMES. THE REVIEWING AGENCY SHALL BE NOTIFIED OF ANY CHANGES TO THE APPROVED PLAN PRIOR TO IMPLEMENTATION OF THOSE CHANGES. THE REVIEWING AGENCY MAY REQUIRE A WRITTEN SUBMITTAL OF THOSE CHANGES FOR REVIEW AND APPROVAL AT ITS DISCRETION.
- 2. AT LEAST 7 DAYS PRIOR TO STARTING ANY EARTH DISTURBANCE ACTIVITIES, INCLUDING CLEARING AND GRUBBING, THE OWNER AND/OR OPERATOR SHALL INVITE ALL CONTRACTORS, THE LANDOWNER, APPROPRIATE MUNICIPAL OFFICIALS, THE E&S PLAN PREPARER, THE PCSM PLAN PREPARER, THE LICENSED PROFESSIONAL RESPONSIBLE FOR OVERSIGHT OF CRITICAL STAGES OF IMPLEMENTATION OF THE PCSM PLAN, AND A REPRESENTATIVE FROM THE LOCAL CONSERVATION DISTRICT TO AN ON-SITE PRECONSTRUCTION MEETING.
- 3. AT LEAST 3 DAYS PRIOR TO STARTING ANY EARTH DISTURBANCE ACTIVITIES, OR EXPANDING INTO AN AREA PREVIOUSLY UNMARKED, THE PENNSYLVANIA ONE CALL SYSTEM INC. SHALL BE NOTIFIED AT 1-800-242-1776 FOR THE LOCATION OF EXISTING UNDERGROUND UTILITIES.
- 4. ALL EARTH DISTURBANCE ACTIVITIES SHALL PROCEED IN ACCORDANCE WITH THE SEQUENCE PROVIDED ON THE PLAN DRAWINGS. DEVIATION FROM THAT SEQUENCE MUST BE APPROVED IN WRITING FROM THE LOCAL CONSERVATION DISTRICT OR BY THE DEPARTMENT PRIOR TO IMPLEMENTATION.
- 5. AREAS TO BE FILLED ARE TO BE CLEARED, GRUBBED, AND STRIPPED OF TOPSOIL TO REMOVE TREES, VEGETATION, ROOTS AND OTHER OBJECTIONABLE MATERIAL.
- 6. CLEARING, GRUBBING, AND TOPSOIL STRIPPING SHALL BE LIMITED TO THOSE AREAS DESCRIBED IN EACH STAGE OF THE CONSTRUCTION SEQUENCE. GENERAL SITE CLEARING, GRUBBING AND TOPSOIL STRIPPING MAY NOT COMMENCE IN ANY STAGE OR PHASE OF THE PROJECT UNTIL THE E&S BMPS SPECIFIED BY THE BMP SEQUENCE FOR THAT STAGE OR PHASE HAVE BEEN INSTALLED AND ARE FUNCTIONING AS DESCRIBED IN THIS E&S PLAN.
- 7. AT NO TIME SHALL CONSTRUCTION VEHICLES BE ALLOWED TO ENTER AREAS OUTSIDE THE LIMIT OF DISTURBANCE BOUNDARIES SHOWN ON THE PLAN MAPS. THESE AREAS MUST BE CLEARLY MARKED AND FENCED OFF BEFORE CLEARING AND GRUBBING OPERATIONS BEGIN.
- 8. TOPSOIL REQUIRED FOR THE ESTABLISHMENT OF VEGETATION SHALL BE STOCKPILED AT THE LOCATION(S) SHOWN ON THE PLAN MAPS(S) IN THE AMOUNT NECESSARY TO COMPLETE THE FINISH GRADING OF ALL EXPOSED AREAS THAT ARE TO BE STABILIZED BY VEGETATION. EACH STOCKPILE SHALL BE PROTECTED IN THE MANNER SHOWN ON THE PLAN DRAWINGS. STOCKPILE HEIGHTS SHALL NOT EXCEED 35 FEET. STOCKPILE SLOPES SHALL BE 2H:1V OR FLATTER.
- 9. IMMEDIATELY UPON DISCOVERING UNFORESEEN CIRCUMSTANCES POSING THE POTENTIAL FOR ACCELERATED EROSION AND/OR SEDIMENT POLLUTION, THE OPERATOR SHALL IMPLEMENT APPROPRIATE BEST MANAGEMENT PRACTICES TO MINIMIZE THE POTENTIAL FOR EROSION AND SEDIMENT POLLUTION AND NOTIFY THE LOCAL CONSERVATION DISTRICT AND/OR THE REGIONAL OFFICE OF THE DEPARTMENT.
- 10. ALL BUILDING MATERIALS AND WASTES SHALL BE REMOVED FROM THE SITE AND RECYCLED OR DISPOSED OF IN ACCORDANCE WITH THE DEPARTMENT'S SOLID WASTE MANAGEMENT REGULATIONS AT 25 PA. CODE 260.1 ET SEQ., 271.1, AND 287.1 ET. SEQ. NO BUILDING MATERIALS OR WASTES OR UNUSED BUILDING MATERIALS SHALL BE BURNED, BURIED, DUMPED, OR DISCHARGED AT THE SITE.
- 11. ALL OFF-SITE WASTE AND BORROW AREAS MUST HAVE AN E&S PLAN APPROVED BY THE LOCAL CONSERVATION DISTRICT OR THE DEPARTMENT FULLY IMPLEMENTED PRIOR TO BEING ACTIVATED.
- 12. THE CONTRACTOR IS RESPONSIBLE FOR ENSURING THAT ANY MATERIAL BROUGHT ON SITE IS CLEAN FILL. FORM FP-001 MUST BE RETAINED BY THE PROPERTY OWNER FOR ANY FILL MATERIAL AFFECTED BY A SPILL OR RELEASE OF A REGULATED SUBSTANCE BUT QUALIFYING AS CLEAN FILL DUE TO ANALYTICAL TESTING.
- 13. ALL PUMPING OF WATER FROM ANY WORK AREA SHALL BE DONE ACCORDING TO THE PROCEDURE DESCRIBED IN THIS PLAN, OVER UNDISTURBED VEGETATED AREAS.
- 14. VEHICLES AND EQUIPMENT MAY NEITHER ENTER DIRECTLY NOR EXIT DIRECTLY FROM LOTS (SPECIFY LOT NUMBERS) ONTO (SPECIFY ROAD NAMES).
- 15. UNTIL THE SITE IS STABILIZED, ALL EROSION AND SEDIMENT BMPS SHALL BE MAINTAINED PROPERLY. MAINTENANCE SHALL INCLUDE INSPECTIONS OF ALL EROSION AND SEDIMENT BMPS AFTER EACH RUNOFF EVENT AND ON A WEEKLY BASIS. ALL PREVENTATIVE AND REMEDIAL MAINTENANCE WORK, INCLUDING CLEAN OUT, REPAIR, REPLACEMENT, REGRADING, RESEEDING, REMULCHING AND RENETTING MUST BE PERFORMED IMMEDIATELY. IF THE E&S BMPS FAIL TO PERFORM AS EXPECTED, REPLACEMENT BMPS, OR MODIFICATIONS OF THOSE INSTALLED WILL BE REQUIRED.
- 16. A LOG SHOWING DATES THAT E&S BMPS WERE INSPECTED AS WELL AS ANY DEFICIENCIES FOUND AND THE DATE THEY WERE CORRECTED SHALL BE MAINTAINED ON THE SITE AND BE MADE AVAILABLE TO REGULATORY AGENCY OFFICIALS AT THE TIME OF INSPECTION.
- 17. SEDIMENT TRACKED ONTO ANY PUBLIC ROADWAY OR SIDEWALK SHALL BE RETURNED TO THE CONSTRUCTION SITE BY THE END OF EACH WORK DAY AND DISPOSED IN THE MANNER DESCRIBED IN THIS PLAN. IN NO CASE SHALL THE SEDIMENT BE WASHED, SHOVELED, OR SWEPT INTO ANY ROADSIDE DITCH, STORM SEWER, OR SURFACE WATER.
- 18. ALL SEDIMENT REMOVED FROM BMPS SHALL BE DISPOSED OF IN THE MANNER DESCRIBED ON THE PLAN DRAWINGS.
- 19. AREAS WHICH ARE TO BE TOPSOILED SHALL BE SCARIFIED TO A MINIMUM DEPTH OF 3 TO 5 INCHES -- 6 TO 12 INCHES ON COMPACTED SOILS -- PRIOR TO PLACEMENT OF TOPSOIL. AREAS TO BE VEGETATED SHALL HAVE A MINIMUM 4 INCHES OF TOPSOIL IN PLACE PRIOR TO SEEDING AND MULCHING. FILL OUTSLOPES SHALL HAVE A MINIMUM OF 2 INCHES OF TOPSOIL.
- 20. ALL FILLS SHALL BE COMPACTED AS REQUIRED TO REDUCE EROSION, SLIPPAGE, SETTLEMENT, SUBSIDENCE OR OTHER RELATED PROBLEMS. FILL INTENDED TO SUPPORT BUILDINGS, STRUCTURES AND CONDUITS, ETC. SHALL BE COMPACTED IN ACCORDANCE WITH LOCAL REQUIREMENTS OR CODES.
- 21. ALL EARTHEN FILLS SHALL BE PLACED IN COMPACTED LAYERS NOT TO EXCEED 9 INCHES IN THICKNESS.22. FILL MATERIALS SHALL BE FREE OF FROZEN PARTICLES, BRUSH, ROOTS, SOD,
- OR OTHER FOREIGN OR OBJECTIONABLE MATERIALS THAT WOULD INTERFERE WITH OR PREVENT CONSTRUCTION OF SATISFACTORY FILLS.
- 23. FROZEN MATERIALS OR SOFT, MUCKY, OR HIGHLY COMPRESSIBLE MATERIALS SHALL NOT BE INCORPORATED INTO FILLS.
- 24. FILL SHALL NOT BE PLACED ON SATURATED OR FROZEN SURFACES.
- 25. SEEPS OR SPRINGS ENCOUNTERED DURING CONSTRUCTION SHALL BE HANDLED IN ACCORDANCE WITH THE STANDARD AND SPECIFICATION FOR SUBSURFACE DRAIN OR OTHER APPROVED METHOD.
- 26. ALL GRADED AREAS SHALL BE PERMANENTLY STABILIZED IMMEDIATELY UPON REACHING FINISHED GRADE. CUT SLOPES IN COMPETENT BEDROCK AND ROCK FILLS NEED NOT BE VEGETATED. SEEDED AREAS WITHIN 50 FEET OF A SURFACE WATER, OR AS OTHERWISE SHOWN ON THE PLAN DRAWINGS, SHALL BE BLANKETED ACCORDING TO THE STANDARDS OF THIS PLAN.
- 27. IMMEDIATELY AFTER EARTH DISTURBANCE ACTIVITIES CEASE IN ANY AREA OR SUBAREA OF THE PROJECT, THE OPERATOR SHALL STABILIZE ALL DISTURBED AREAS. DURING NON-GERMINATING MONTHS, MULCH OR PROTECTIVE BLANKETING SHALL BE APPLIED AS DESCRIBED IN THE PLAN. AREAS NOT AT

- FINISHED GRADE, WHICH WILL BE REACTIVATED WITHIN 1 YEAR, MAY BE STABILIZED IN ACCORDANCE WITH THE TEMPORARY STABILIZATION SPECIFICATIONS. THOSE AREAS WHICH WILL NOT BE REACTIVATED WITHIN 1 YEAR SHALL BE STABILIZED IN ACCORDANCE WITH THE PERMANENT STABILIZATION SPECIFICATIONS.
- 28. PERMANENT STABILIZATION IS DEFINED AS A MINIMUM UNIFORM, PERENNIAL 70% VEGETATIVE COVER OR OTHER PERMANENT NON-VEGETATIVE COVER WITH A DENSITY SUFFICIENT TO RESIST ACCELERATED EROSION. CUT AND FILL SLOPES SHALL BE CAPABLE OF RESISTING FAILURE DUE TO SLUMPING, SLIDING, OR OTHER MOVEMENTS.
- 29. E&S BMPS SHALL REMAIN FUNCTIONAL AS SUCH UNTIL ALL AREAS TRIBUTARY TO THEM ARE PERMANENTLY STABILIZED OR UNTIL THEY ARE REPLACED BY ANOTHER BMP APPROVED BY THE LOCAL CONSERVATION DISTRICT OR THE DEPARTMENT.
- 30. UPON COMPLETION OF ALL EARTH DISTURBANCE ACTIVITIES AND PERMANENT STABILIZATION OF ALL DISTURBED AREAS, THE OWNER AND/OR OPERATOR SHALL CONTACT THE LOCAL CONSERVATION DISTRICT FOR AN INSPECTION PRIOR TO REMOVAL/CONVERSION OF THE E&S BMPS.
- 31. AFTER FINAL SITE STABILIZATION HAS BEEN ACHIEVED, TEMPORARY EROSION AND SEDIMENT BMPS MUST BE REMOVED OR CONVERTED TO PERMANENT POST CONSTRUCTION STORMWATER MANAGEMENT BMPS. AREAS DISTURBED DURING REMOVAL OR CONVERSION OF THE BMPS SHALL BE STABILIZED IMMEDIATELY. IN ORDER TO ENSURE RAPID REVEGETATION OF DISTURBED AREAS, SUCH REMOVAL/CONVERSIONS ARE TO BE DONE ONLY DURING THE GERMINATING SEASON.
- 32. UPON COMPLETION OF ALL EARTH DISTURBANCE ACTIVITIES AND PERMANENT STABILIZATION OF ALL DISTURBED AREAS, THE OWNER AND/OR OPERATOR SHALL CONTACT THE LOCAL CONSERVATION DISTRICT TO SCHEDULE A FINAL INSPECTION.
- 33. FAILURE TO CORRECTLY INSTALL E&S BMPS, FAILURE TO PREVENT SEDIMENT-LADEN RUNOFF FROM LEAVING THE CONSTRUCTION SITE, OR FAILURE TO TAKE IMMEDIATE CORRECTIVE ACTION TO RESOLVE FAILURE OF E&S BMPS MAY RESULT IN ADMINISTRATIVE, CIVIL, AND/OR CRIMINAL PENALTIES BEING INSTITUTED BY THE DEPARTMENT AS DEFINED IN SECTION 602 OF THE PENNSYLVANIA CLEAN STREAMS LAW. THE CLEAN STREAMS LAW PROVIDES FOR UP TO \$10,000 PER DAY IN CIVIL PENALTIES, UP TO \$10,000 IN SUMMARY CRIMINAL PENALTIES, AND UP TO \$25,000 IN MISDEMEANOR CRIMINAL PENALTIES FOR EACH VIOLATION.

CONSTRUCTION SEQUENCE

- 1. AT LEAST 7 DAYS PRIOR TO STARTING ANY EARTH DISTURBANCE ACTIVITIES (INCLUDING CLEARING AND GRUBBING), THE OWNER AND/OR OPERATOR SHALL INVITE ALL CONTRACTORS, THE LANDOWNER, APPROPRIATE MUNICIPAL OFFICIALS, THE E&S PLAN PREPARER, THE PCSM PLAN PREPARER, AND A REPRESENTATIVE FROM THE MONTGOMERY CONSERVATION DISTRICT TO AN ON-SITE PRE-CONSTRUCTION MEETING.
- 2. UPON INSTALLATION OR STABILIZATION OF ALL PERIMETER SEDIMENT CONTROL BMPS AND AT LEAST 3 DAYS PRIOR TO PROCEEDING WITH THE BULK EARTH DISTURBANCE ACTIVITIES, THE PERMITTEE OR CO-PERMITTEE SHALL PROVIDE NOTIFICATION TO THE DEPARTMENT OR AUTHORIZED CONSERVATION DISTRICT.
- 3. AT LEAST 3 DAYS PRIOR TO STARTING ANY EARTH DISTURBANCE ACTIVITIES, OR EXPANDING INTO AN AREA PREVIOUSLY UNMARKED, THE PENNSYLVANIA ONE CALL SYSTEM INC. SHALL BE NOTIFIED AT 1-800-242-1776 FOR THE LOCATION OF EXISTING UNDERGROUND UTILITIES.
- 4. ALL EARTH DISTURBANCE ACTIVITIES SHALL PROCEED IN ACCORDANCE WITH THE SEQUENCE PROVIDED ON THE PLAN DRAWINGS. DEVIATION FROM THAT SEQUENCE MUST BE APPROVED BY THE MONTGOMERY CONSERVATION DISTRICT OR BY THE DEPARTMENT PRIOR TO IMPLEMENTATION. EACH STEP OF THE SEQUENCE SHALL BE COMPLETED BEFORE PROCEEDING TO THE NEXT STEP, EXCEPT WHERE NOTED.
- 5. CONSTRUCTION BEGINS.
- 6. THE EXISTING DRIVEWAY IS TO ACT AS THE CONSTRUCTION ENTRANCE DURING CONSTRUCTION. THIS ENTRANCE MUST BE UTILIZED BY ALL CONSTRUCTION VEHICLES ENTERING/EXITING THE SITE. STREET SWEEPING AT THE CONSTRUCTION ENTRANCE SHALL BE PERFORMED AT THE END OF THE DAY AND AS NEEDED THROUGHOUT THE LIFE OF THE PROJECT. A PILE OF BALLASTS SHALL BE KEPT ON SITE TO REFRESH THE ENTRANCE AS NEEDED.
- 7. INSTALL TREE PROTECTION FENCING AS INDICATED ON PLAN. TREE PROTECTION FENCING MUST BE IN PLACE AND APPROVED PRIOR TO ANY DISTURBANCE. THE LIMIT OF DISTURBANCE SHALL BE CLEARLY MARKED. ALL DISTURBANCE SHALL BE CONTAINED TO THE DELINEATED LIMIT OF CONSTRUCTION.
- 8. INSTALL SILT FENCE AS INDICATED ON PLAN. SILT FENCE SHALL BE INSTALLED UP-SLOPE OF CONSTRUCTION FENCING. <u>NOTE:</u> ADDITIONAL SEDIMENT BARRIERS SHALL BE INSTALLED DOWNGRADE OF ANY DISTURBANCE AREAS AS NEEDED THROUGHOUT THE ENTIRE PROJECT.
- 9. INSTALL ORANGE CONSTRUCTION FENCING AROUND AREAS OF PROPOSED INFILTRATION PRIOR TO ANY EARTH DISTURBANCE TO PREVENT POTENTIAL COMPACTION. BED AREAS TO BE PROTECTED THROUGHOUT EARTHWORK ACTIVITIES.
- 10. PRIOR TO COMMENCEMENT OF EARTH WORK OR GROUND DISTURBANCE ACTIVITY, ALL EROSION CONTROL FACILITIES REQUIRED PURSUANT TO THE APPROVED PERMIT PLAN MUST BE INSTALLED. ALL MEASURES NECESSARY TO PREVENT SEDIMENT FROM LEAVING THE SITE MUST BE TAKEN BY THE APPLICANT AND BUILDER/CONTRACTOR THROUGHOUT THE ENTIRE PERIOD OF CONSTRUCTION UNTIL THE SITE IS PERMANENTLY STABILIZED, REGARDLESS OF WHETHER OR NOT SUCH MEASURES ARE SPECIFICALLY SHOWN ON THE PERMIT/PLAN. SEDIMENT FROM THIS SITE MAY NOT CONTAMINATE ON-SITE OR OFF-SITE WATERWAYS.
- 11. CLEAR AND GRUB THE AREAS AS NECESSARY WITHIN THE LIMITS OF DISTURBANCE OF EXISTING VEGETATION. STRIP TOPSOIL AND STOCKPILE SUITABLE MATERIAL FOR FUTURE USE. UNSUITABLE MATERIAL SHALL BE DISPOSED OF PROPERLY. SURROUND STOCKPILE WITH SILT FENCE. TEMPORARILY SEED ALL STOCKPILED TOPSOIL.
- 12. GRADE AND CONSTRUCT PROPOSED SOUTHERN ADA PARKING SPOT TO PROVIDE AN ACCESSIBLE SPOT PRIOR TO THE REST OF THE CONSTRUCTION.
- 13. ROUGH GRADE THE SITE TO ENABLE THE CONSTRUCTION OF THE NEW IMPROVEMENTS. ANY GRADED OR DISTURBED AREA MUST BE TEMPORARILY SEEDED IF NO EARTH MOVING IS ANTICIPATED FOR MORE THAN 4 DAYS.
- 14. AS SOON AS ANY DISTURBED AREA IS BROUGHT TO FINAL GRADE THE AREA MUST BE STABILIZED. NO MORE THAN 15,000 SF OF DISTURBED AREA SHALL REACH FINAL GRADE BEFORE INITIATING SEEDING AND MULCHING OPERATIONS.
- 15. INSTALL THE NEW INLETS, SUMP BOXES, AND ASSOCIATED CONVEYANCE PIPING AS SHOWN ON THE PLANS. ALL INLETS SHALL BE COMPLETELY SEALED OFF UNTIL THE CONTRIBUTORY AREA TO THE INLETS ARE PERMANENTLY STABILIZED AS SHOWN ON THE "INLET BLOCKING DETAIL" ON THE PLANS.
- 16. STABILIZE AND INSTALL TEMPORARY GROUND COVER VEGETATION ON GRADED AREAS THAT REMAIN UNDISTURBED DURING BUILDING CONSTRUCTION. ANY GRADED OR DISTURBED AREAS MUST BE TEMPORARILY SEEDED IF NO FURTHER EARTH MOVING IS ANTICIPATED IMMEDIATELY.
- 17. INSPECT SEDIMENT BARRIERS WEEKLY AND AFTER EACH RAINFALL EVENT GREATER THAN 0.25 INCHES. WRITTEN DOCUMENTATION OF THESE INSPECTIONS SHOULD BE MAINTAINED ON THE PROJECT SITE AND BE AVAILABLE UPON REQUEST. NOTE: E&S CONTROLS ARE NOT TO BE REMOVED UNTIL UNIFORM 70% VEGETATIVE COVER OF EROSION RESISTANT PERENNIAL SPECIES OVER THE ENTIRE DISTURBED AREA. (SEE CONSTRUCTION SEQUENCE NOTE #22 FOR STABILIZATION CRITERIA).
- 18. REPLACE AND REPAIR SEDIMENT BARRIERS AS NECESSARY.

19. CRITICAL STAGE - (THE SITE'S ENGINEER OR DESIGNEE SHALL BE ON SITE TO INSPECT THE INSTALLATION OF THE PCSM FACILITIES) STABILIZE THE CONTRIBUTORY AREA. EXCAVATE FOR AND INSTALL THE PERMANENT PCSM SYSTEMS. EXCAVATE TO THE BOTTOM OF THE PERMANENT SYSTEM. AS INDICATED ON THE PLANS. INSTALL GEOTEXTILE FABRIC, PIPE BEDDING AND PIPE SYSTEM AS INDICATED ON THE PLANS. INSTALLATION OF THE STONE SHALL BE CHECKED BY THE DESIGN OR SITE ENGINEER PRIOR TO INSTALLATION INTO THE INFILTRATION BMPS TO ENSURE THAT IT IS CLEAN WASHED STONE. IN THE EVENT THAT SEDIMENT ENTERS OR CLOGS THE INFILTRATION BMP APPROPRIATE MEASURES SHALL BE TAKEN (I.E. CLEANING THE SOIL/SEDIMENT FROM THE FABRIC, STONE, BED, ETC. AND OR REPLACEMENT OF THE FABRIC AND STONE). IF GROUNDWATER OR BEDROCK IS FOUND DURING THE EXCAVATION OF THE PIPE SYSTEM, THE ENGINEER SHALL BE CONSULTED TO DETERMINE THE NECESSARY MEASURES THAT SHOULD BE TAKEN. THE BOTTOM OF ALL INFILTRATION BMPS SHALL BE UNDISTURBED OR UNCOMPACTED SUBGRADE. CONNECT SYSTEMS TO THE RESPECTIVE LEVEL SPREADERS, AND CONNECT INLETS TO THE PCSM SYSTEMS AS SHOWN ON THE PLANS.

a. ALL BED BOTTOMS SHALL BE LEVEL AFTER GRADING.

- b. PRIOR TO INFILTRATION BED GRADING AND PLACEMENT OF GEOTEXTILE, UP-GRADIENT AREAS SHALL BE SUFFICIENTLY STABILIZED TO PREVENT THE WASHING OF SEDIMENT INTO THE RECHARGE AREAS. IT IS THE CONTRACTOR'S RESPONSIBILITY TO PREVENT THE DEPOSITION OF SEDIMENT OR SEDIMENT-LADEN WATERS INTO THE INFILTRATION STRUCTURES AFTER FINAL GRADING.
- c. IF BEDROCK IS ENCOUNTERED AT ANY TIME DURING EXCAVATION OF THE INFILTRATION BED, EXCAVATION IS TO BE DISCONTINUED IN THE AFFECTED AREA AND THE OWNER AND ENGINEER NOTIFIED AT ONCE.
- d. PLACE GEOTEXTILE IN ACCORDANCE WITH MANUFACTURER'S STANDARDS AND RECOMMENDATIONS. ADJACENT STRIPS OF GEOTEXTILE SHALL OVERLAP A MINIMUM OF TWO FEET. SECURE FABRIC AT LEAST FOUR (4) FEET OUTSIDE OF BED AND TAKE STEPS NECESSARY TO PREVENT ANY SEDIMENT FROM ENTERING TRENCH.
- e. AGGREGATE SHALL BE CLEAN WITH A WASH LOSS OF NO MORE THAN 0.5 PERCENT. INSTALLATION OF THE STONE SHOULD BE CHECKED BY THE DESIGN OR SITE ENGINEER PRIOR TO INSTALLATION INTO THE INFILTRATION BMP TO ENSURE THAT IT IS CLEAN WASHED STONE. AGGREGATE THAT DOES NOT MEET THIS CRITERION WILL BE REMOVED AT NO EXTRA COST TO THE OWNER AND THE BEDS RESTORED TO THE OWNER'S SATISFACTION.
- f. FOLLOWING PLACEMENT OF BED AGGREGATE, THE GEOTEXTILE SHALL BE FOLDED OVERTOP THE BED, WITH APPROPRIATE FABRIC OVERLAP, TO PROTECT FROM SEDIMENT WASHOUT ALONG BED EDGES. TOPSOIL (OR APPROPRIATE MATERIAL SPECIFIED BY PARTICULAR DESIGN) WILL BE USED TO FILL ABOVE THE BED TO THE SPECIFIED HEIGHT.
- 21. BEGIN DEMOLITION AND REMOVAL OF THE EXISTING BUILDING AND ASPHALT DRIVEWAY AS SHOWN ON THE PLANS. CONSTRUCTION DEBRIS SHALL BE REMOVED FROM THE SITE IN AN APPROVED MANNER.
- 22. UNTIL THE SITE IS STABILIZED ALL EROSION AND SEDIMENTATION CONTROLS MUST BE MAINTAINED PROPERLY. THE SITE SHALL BE DEEMED STABILIZED WHEN VEGETATED AREAS ACHIEVE A MINIMUM UNIFORM 70% PERENNIAL VEGETATIVE COVER OVER THE ENTIRE DISTURBED AREAS AND ROADWAYS/PARKING AREAS SHOULD ATLEAST HAVE A CLEAN SUBBASE IN PLACE (PAGE 10 OF THE PADEP E&SC MANUAL). MAINTENANCE MUST INCLUDE INSPECTIONS OF ALL EROSION AND SEDIMENTATION CONTROLS AFTER EACH RUNOFF EVENT AND ON A WEEKLY BASIS. ALL PREVENTATIVE AND REMEDIAL MAINTENANCE WORK; INCLUDING CLEAN OUT, REPAIR, REPLACEMENT, REGRADING, RESEEDING, REMULCHING, AND RENETTING, MUST BE PERFORMED IMMEDIATELY.
- 23. UPON COMPLETION OR TEMPORARY CESSATION OF THE EARTH DISTURBANCE ACTIVITY THAT WILL EXCEED 4 DAYS, OR ANY STAGE THEREOF, THE PROJECT SITE SHALL BE IMMEDIATELY STABILIZED WITH THE APPROPRIATE TEMPORARY OR PERMANENT STABILIZATION. HYDROSEED IS NOT CONSIDERED STABILIZATION UNTIL IT GERMINATES. HAY OR STRAW MULCH MUST BE APPLIED AT 3.0 TONS PER ACRE.
- 24. INSTALL THE NEW PAVEMENT AREAS.
- 25. REMOVE THE INLET BLOCKING MATERIALS FROM THE INLETS TO ALLOW RUNOFF TO ENTER THE INLETS.
- 26. REMOVE EXCAVATED MATERIALS NOT REQUIRED FOR FINAL CONSTRUCTION FROM SITE AND DISPOSE OF THEM IN AN APPROVED MANNER.
- 27. REMOVE ANY ACCUMULATED SURPLUS STORAGE MATERIALS AND STAGING AREA AND ROUGH/FINAL GRADE AREAS OF REMOVALS; AND STABILIZE
- 28. SPREAD STOCKPILED TOPSOIL AROUND BUILDING AND ALL DISTURBED AREAS. SEED ALL GRADED AREAS TO RE-ESTABLISH VEGETATION. STABILIZED SLOPES IN EXCESS OF 4:1 WITH SOD OR NETTING AND MULCH
- 29. REMOVE CONSTRUCTION FENCING AND SPREAD STOCKPILE TOPSOIL OVER REMAINING DISTURBED AREAS. SEED ALL GRADED AREAS TO RE-ESTABLISH VEGETATION. ALL SLOPES IN EXCESS OF 4:1 SHALL BE STABILIZED IMMEDIATELY. NOTE: E&S CONTROLS ARE NOT TO BE REMOVED UNTIL UNIFORM 70% VEGETATIVE COVER OF EROSION RESISTANT PERENNIAL SPECIES OVER THE ENTIRE DISTURBED AREA. (SEE CONSTRUCTION SEQUENCE NOTE #22 FOR STABILIZATION CRITERIA).
- 30. INSTALL LANDSCAPE MATERIALS AND HARDSCAPE MATERIALS.
- 31. UPON THE RE-ESTABLISHMENT OF VEGETATION ON ALL DENUDED AREAS, REMOVE ALL SEDIMENT BARRIERS.
- 32. STABILIZE AND SEED ANY AREAS DISTURBED BY THE REMOVAL OF SEDIMENT BARRIERS.
- 33. CONSTRUCTION FINISHED.

DUST CONTROL NOTES

- 1. FUGITIVE DUST FORM CONSTRUCTION, DEMOLITION, AND EARTHWORKS ACTIVITIES MAY NOT BE VISIBLE AT THE POINT IT PASSES THE WORKSITE PROPERTY LINE.
- 2. USE OF VACUUM OR SIMILAR SUCTION SYSTEMS TO CAPTURE DUST KICKED UP BY POWER TOOLS WHEN GRINDING / CUTTING.
- 3. APPLICATION OF WATER OR APPROVED DUST SUPPRESSANT TO A WORKSITE WITH ONGOING EXCAVATION, LAND CLEARING, DEMOLITION, OR OTHER EARTH DISTURBANCE RELATED ACTIVITIES TO SUPPRESS DUST FORMATION.
- GENERAL PROHIBITION AGAINST DRY ABRASIVE BLASTING OF EXTERIOR SURFACES OPEN TO THE OUTSIDE AIR WHEN TEMPERATURE IS ABOVE FREEZING.
- 5. COVERING AND WETTING OF STOCKPILED EARTH, SAND, GRAVEL, AND OTHER SIMILAR CONSTRUCTION MATERIALS.
- 6. ALL TEMPORARY PERIMETER FENCING AROUND MUST HAVE DUST CONTROL FABRIC; MUST MEASURE A MINIMUM OF 5 FT IN HEIGHT FROM THE BOTTOM OF THE FENCING.
- 7. A 10 MILES PER HOUR SPEED LIMIT FOR ALL EQUIPMENT AND TRUCKS TRAVELING WITHIN THE WORKSITE.
- 8. WETTING AND SWEEPING OF ROADWAYS / ACCESS ROADS IN A WORKSITE TO PREVENT DUST FORMATION.
- 9. VEHICLE ACCESS POINTS MUST BE EQUIPPED WITH DUST SUPPRESSION MEASURES (I.E. WHEEL WASH SYSTEMS, RUMBLE GRATES, AND/OR GRAVEL PADS)


LAWN RESTORATION MIX, PLANTING RATES AND PLANTING DATES RATES RECOMMENDED OPTIMUM RED MIXTURE LEG MIXTURE RECOMMENDED OPTIMUM RECOMMENDED OPTIMUM RECOMMENDED OPTIMUM

	RATES		RECOMMENDED OPTIMUM
SEED MIXTURE	LBS / AC.	LBS / 1000 S.F.	PLANTING PERIOD
TURF-TYPE TALL FESCUE (BLEND OF 3 LOCAL CULTIVARS)	350	8	08/15 - 10/15
DEERTONGUE	20	.45	
REDTOP	02	.05	03/01 - 04/30
WILD RYE (ELYMUS)	15	.35	00/01 - 04/00
SWITCHGRASS	25	.60	

ABINGTON INCLUSIVE PLAYGROUND PROJECT



OWNER: ABINGTON TOWNSHIP 1176 OLD YORK RD, ABINGTON, PA 19001 (267) 536-1000

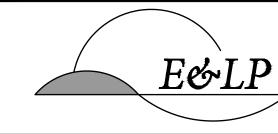

140 WEST MAIN STREET HIGH BRIDGE, NJ 08829 PH. 908-238-0544 FAX. 908-238-9572 A PROFESSIONAL ASSOCIATION



EDWARD D. CONFAIR PROFESSIONAL ENGINEER PENNSYLVANIA PE092932

STUDIO LUDO 1313 S 33RD STREET UNIT A PHILADELPHIA, PA 19146 (215) 454-6780



SAS GEOSPATIAL, LLC 1432 EASTON ROAD SUITE 5F WARRINGTON, PA 18976 (215) 343-5989



ABINGTON INCLUSIVE PARK AND PLAYGROUND

ROYCHESTER PARK TAX MAP ID 30251 013 ABINGTON TOWNSHIP, MONTGOMERY COUNTY, PA

	100% CONSTRUCTION DOCUMENTS	09/27/20
)	50% CONSTRUCTION DOCUMENTS	08/30/20
	REVISED PER ENGINEER COMMENTS	07/25/20
	100% DESIGN DEVELOPMENT	06/05/2
).	ISSUANCE	DATE
LE	:	

SESC NOTES & DETAILS


JOB NO.:	0222032
SCALE:	AS SHOWN
DESIGNED:	MMS
CHECKED:	EDC
FILENAME: C-610 SES	C NOTES & DETAILS.DWG
DATE:	06/02/2023

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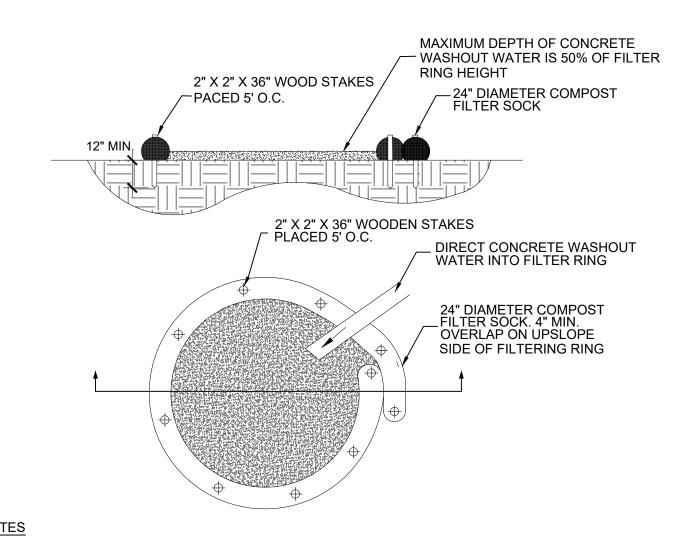
ENGINEERING & LAND PLANNING ASSOC., INC.

C-610

DRAWING NO.:

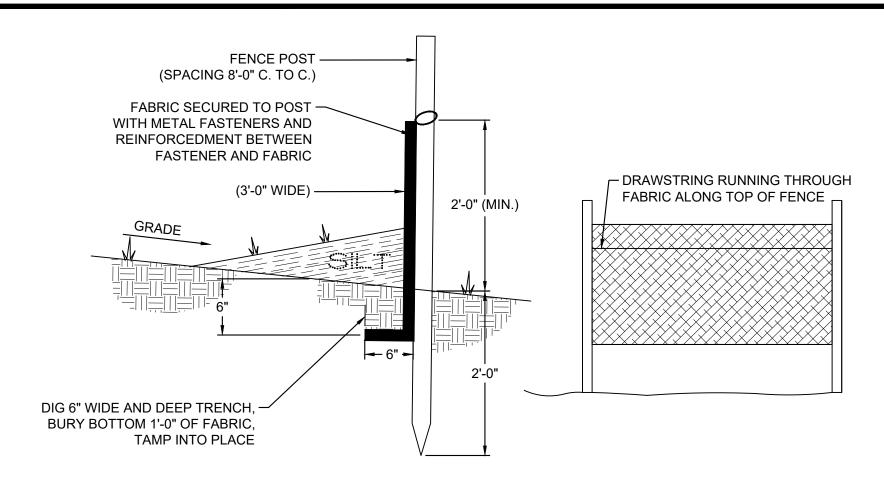

SILT FENCE DETAIL



- 1. A SUITABLE IMPERVIOUS GEOMEMBRANE SHALL BE PLACED AT THE LOCATION OF THE WASHOUT PRIOR TO INSTALLING THE SOCKS.
- 2. INSTALL ON FLAT GRADE FOR OPTIMUM PERFORMANCE
- 3. 18" DIAMETER FILTER SICK MAY BE STACKED ONTO DOUBLE 24" DIAMETER SOCKS IN PYRAMIDAL CONFIGURATION FOR
- 4. PROVIDE PROPER SIGNAGE TO DRIVERS SO THAT THEY ARE AWARE OF THE PRESENCE OF
- WASHOUT FACILITIES.

ADDED HEIGHT.

- 5. NOT TO BE PLACED WITHIN 50 FEET OF STORM DRAINS, OPEN DITCHES OR SURFACE WATERS. 6. MUST BE LOCATED IN A CONVENIENT LOCATION FOR THE TRUCKS BUT FAR ENOUGH FROM OTHER
- VEHICULAR TRAFFIC TO MINIMIZE THE POTENTIAL FOR ACCIDENTAL DAMAGE OR SPILLS.

CONCRETE WASHOUT DETAIL

- COVER - SINGLE PIECE HEAVY DUTY PLASTIC OR REINFORCED - HAYBALE PERIMETER -SANDBAG -BOTTOM LINER - SINGLE PIECE HEAVY DUTY PLASTIC

HAYBALE PERIMETER 1. THE STOCKPILE AREAS WILL BE CONSTRUCTED TO MEET 40 CFR 761.65 (c)(9).

-PROTECTIVE FENCE AROUND PROTECTED ROOT ZONE (PRZ)

TEMPORARY SOIL STOCKPILE DETAIL

NOTES:

STAPLES IS 6"

ON EITHER SIDE.

NTS

STAPLES.

1. KEY-IN THE MATTING BY PLACING THE TOP

2. STAPLE THE 4" OVERLAP IN THE CHANNEL

3. BEFORE STAPLING THE OUTER EDGES OF THE MATTING, MAKE SURE THE MATTING IS SMOOTH AND IN FIRM CONTACT WITH THE

4. STAPLES SHALL BE PLACED 2' APART WITH 4 ROWS FOR EACH STRIP, 2 OUTER ROWS, AND 2

ANOTHER BEGINS, THE END OF THE TOP STRIP

ALTERNATING ROWS DOWN THE CENTER. 5. WHEN ONE ROOL OF MATTING ENDS AND

SHALL OVERLAP THE UPPER END OF THE

6. THE DISCHARGE END OF THE MATTING

DOUBLE ROWS OF STAPLES.

THE FLOW MUST BE KEYED-IN.

LINER SHOULD BE SIMILARLY SECURED WITH 2

7. IF FLOW WILL ENTER FROM THE EDGE OF

THE MATTING THEN THE AREA EFFECTED BY

LWOER STRIP BY 4". REINFORCE THE OVERLAP WITH A DOUBLE ROW OF STAPLES SPACED 6" APART IN A STAGGERED PATTERN

CENTER USING AN 18" SPACING BETWEEN


FIRMLY TO CONFORM TO THE CHANNEL CROSS-SECTION. SPACING BETWEEN

ENDS OF THE MATTING IN A NARROW TRNECH, 6" IN DEPTH. BACKFILL THE TRENCH AND TAMP TREE PROTECTION DETAIL

FLARED END SECTION -

CROSS-SECTION TYPICAL STAPLES NO. 11 GAUGE WIRE

EROSION CONTROL MATTING DETAIL

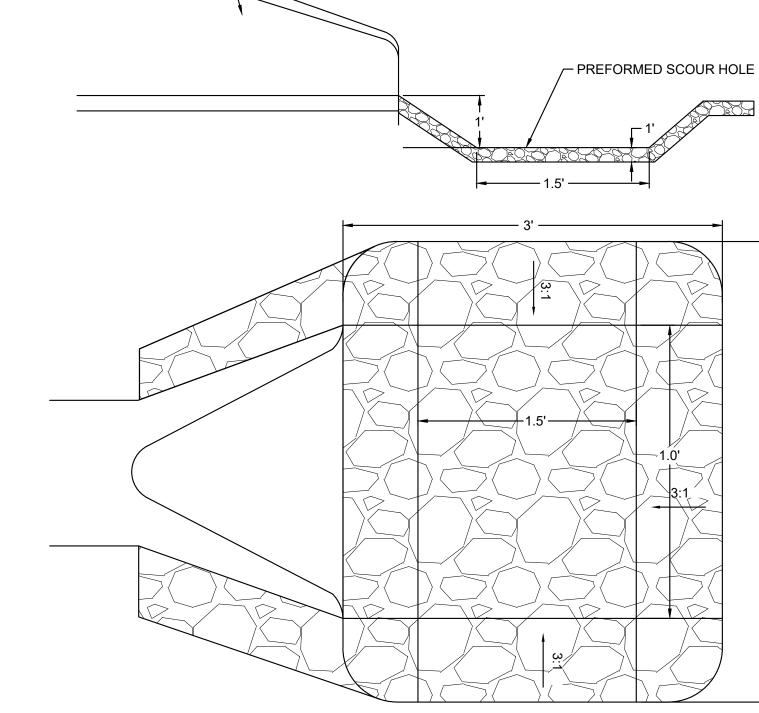


SCOUR HOLE DETAIL

ESTIMATE A TREE'S PROTECTED ROOT ZONE (PRZ) BY

CALCULATING THE CRITICAL ROOT RADIUS (CRR)

- 1. MEASURE THE DBH (DIAMETER OF TREE AT BREAST HEIGHT, 4.5 FEET ABOVE GROUND ON THE UPHILL
- SIDE OF TREE IN INCHES) 2. MULTIPLY MEASURED DBH BY 1.5 OR 1.0. EXPRESS THE RESULT IN FEET.

-DBH X 1.5: CRITICAL ROOT RADIUS FOR OLDER, UNHEALTHY OR SENSITIVE SPECIES. -DBH X 1.0: CRITICAL ROOT RADIUS FOR YOUNGER, HEALTHY OR TOLERANT SPECIES.

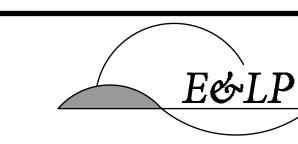

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ABINGTON INCLUSIVE

PLAYGROUND PROJECT



DATE

OWNER:

ABINGTON TOWNSHIP

1176 OLD YORK RD,

ABINGTON, PA 19001 (267) 536-1000

EDWARD D. CONFAIR

PROFESSIONAL ENGINEER PENNSYLVANIA PE092932

STUDIO LUDO 1313 S 33RD STREET UNIT A PHILADELPHIA. PA 19146 (215) 454-6780



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ABINGTON INCLUSIVE PARK AND PLAYGROUND

ROYCHESTER PARK TAX MAP ID 30251 013 ABINGTON TOWNSHIP, MONTGOMERY COUNTY, PA


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)3	50% CONSTRUCTION DOCUMENTS	08/30/2023
)2	REVISED PER ENGINEER COMMENTS	07/25/2023
)1	100% DESIGN DEVELOPMENT	06/05/23
Ю.	ISSUANCE	DATE


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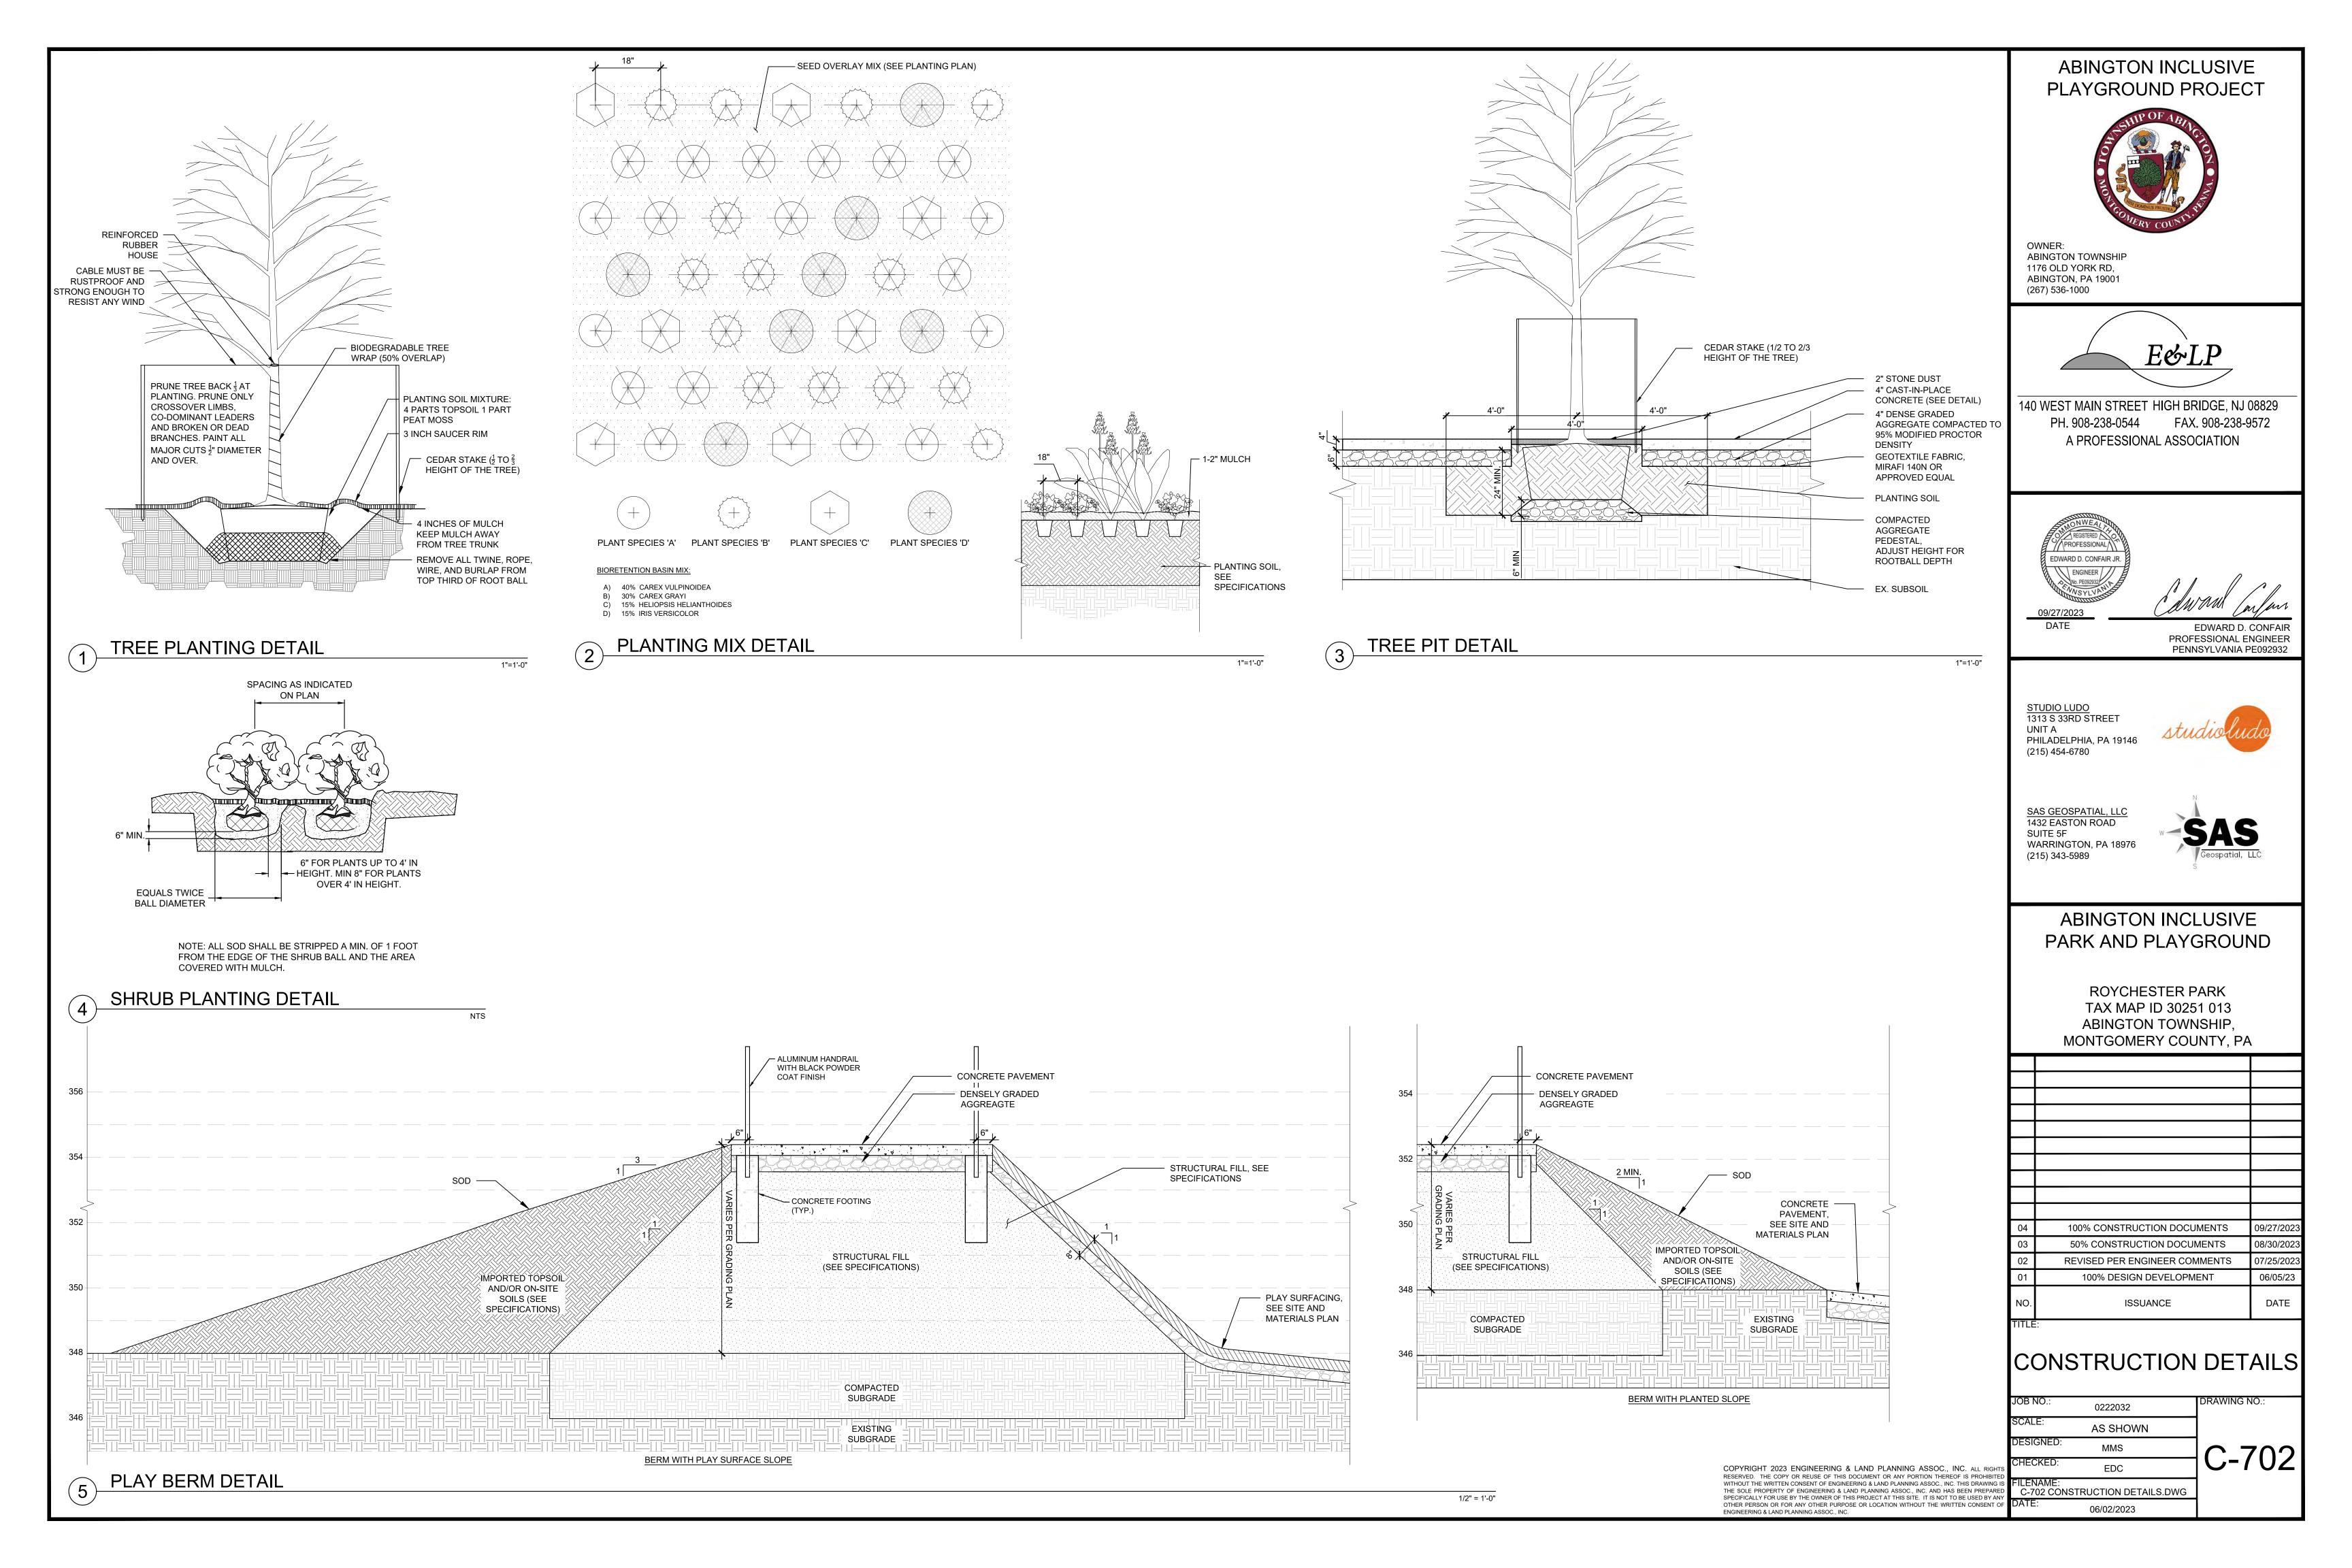
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ΓE:	06/02/2023	


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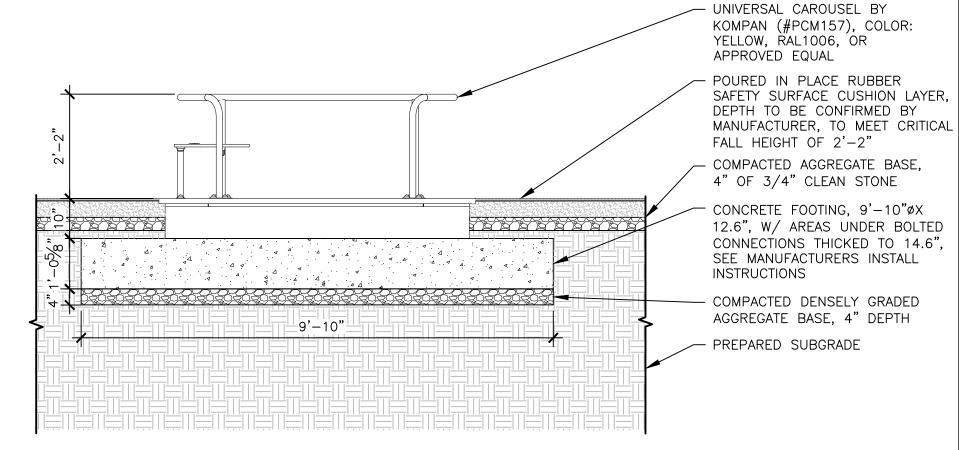




PIP SAFETY SURFACE AT PLANTING DETAIL

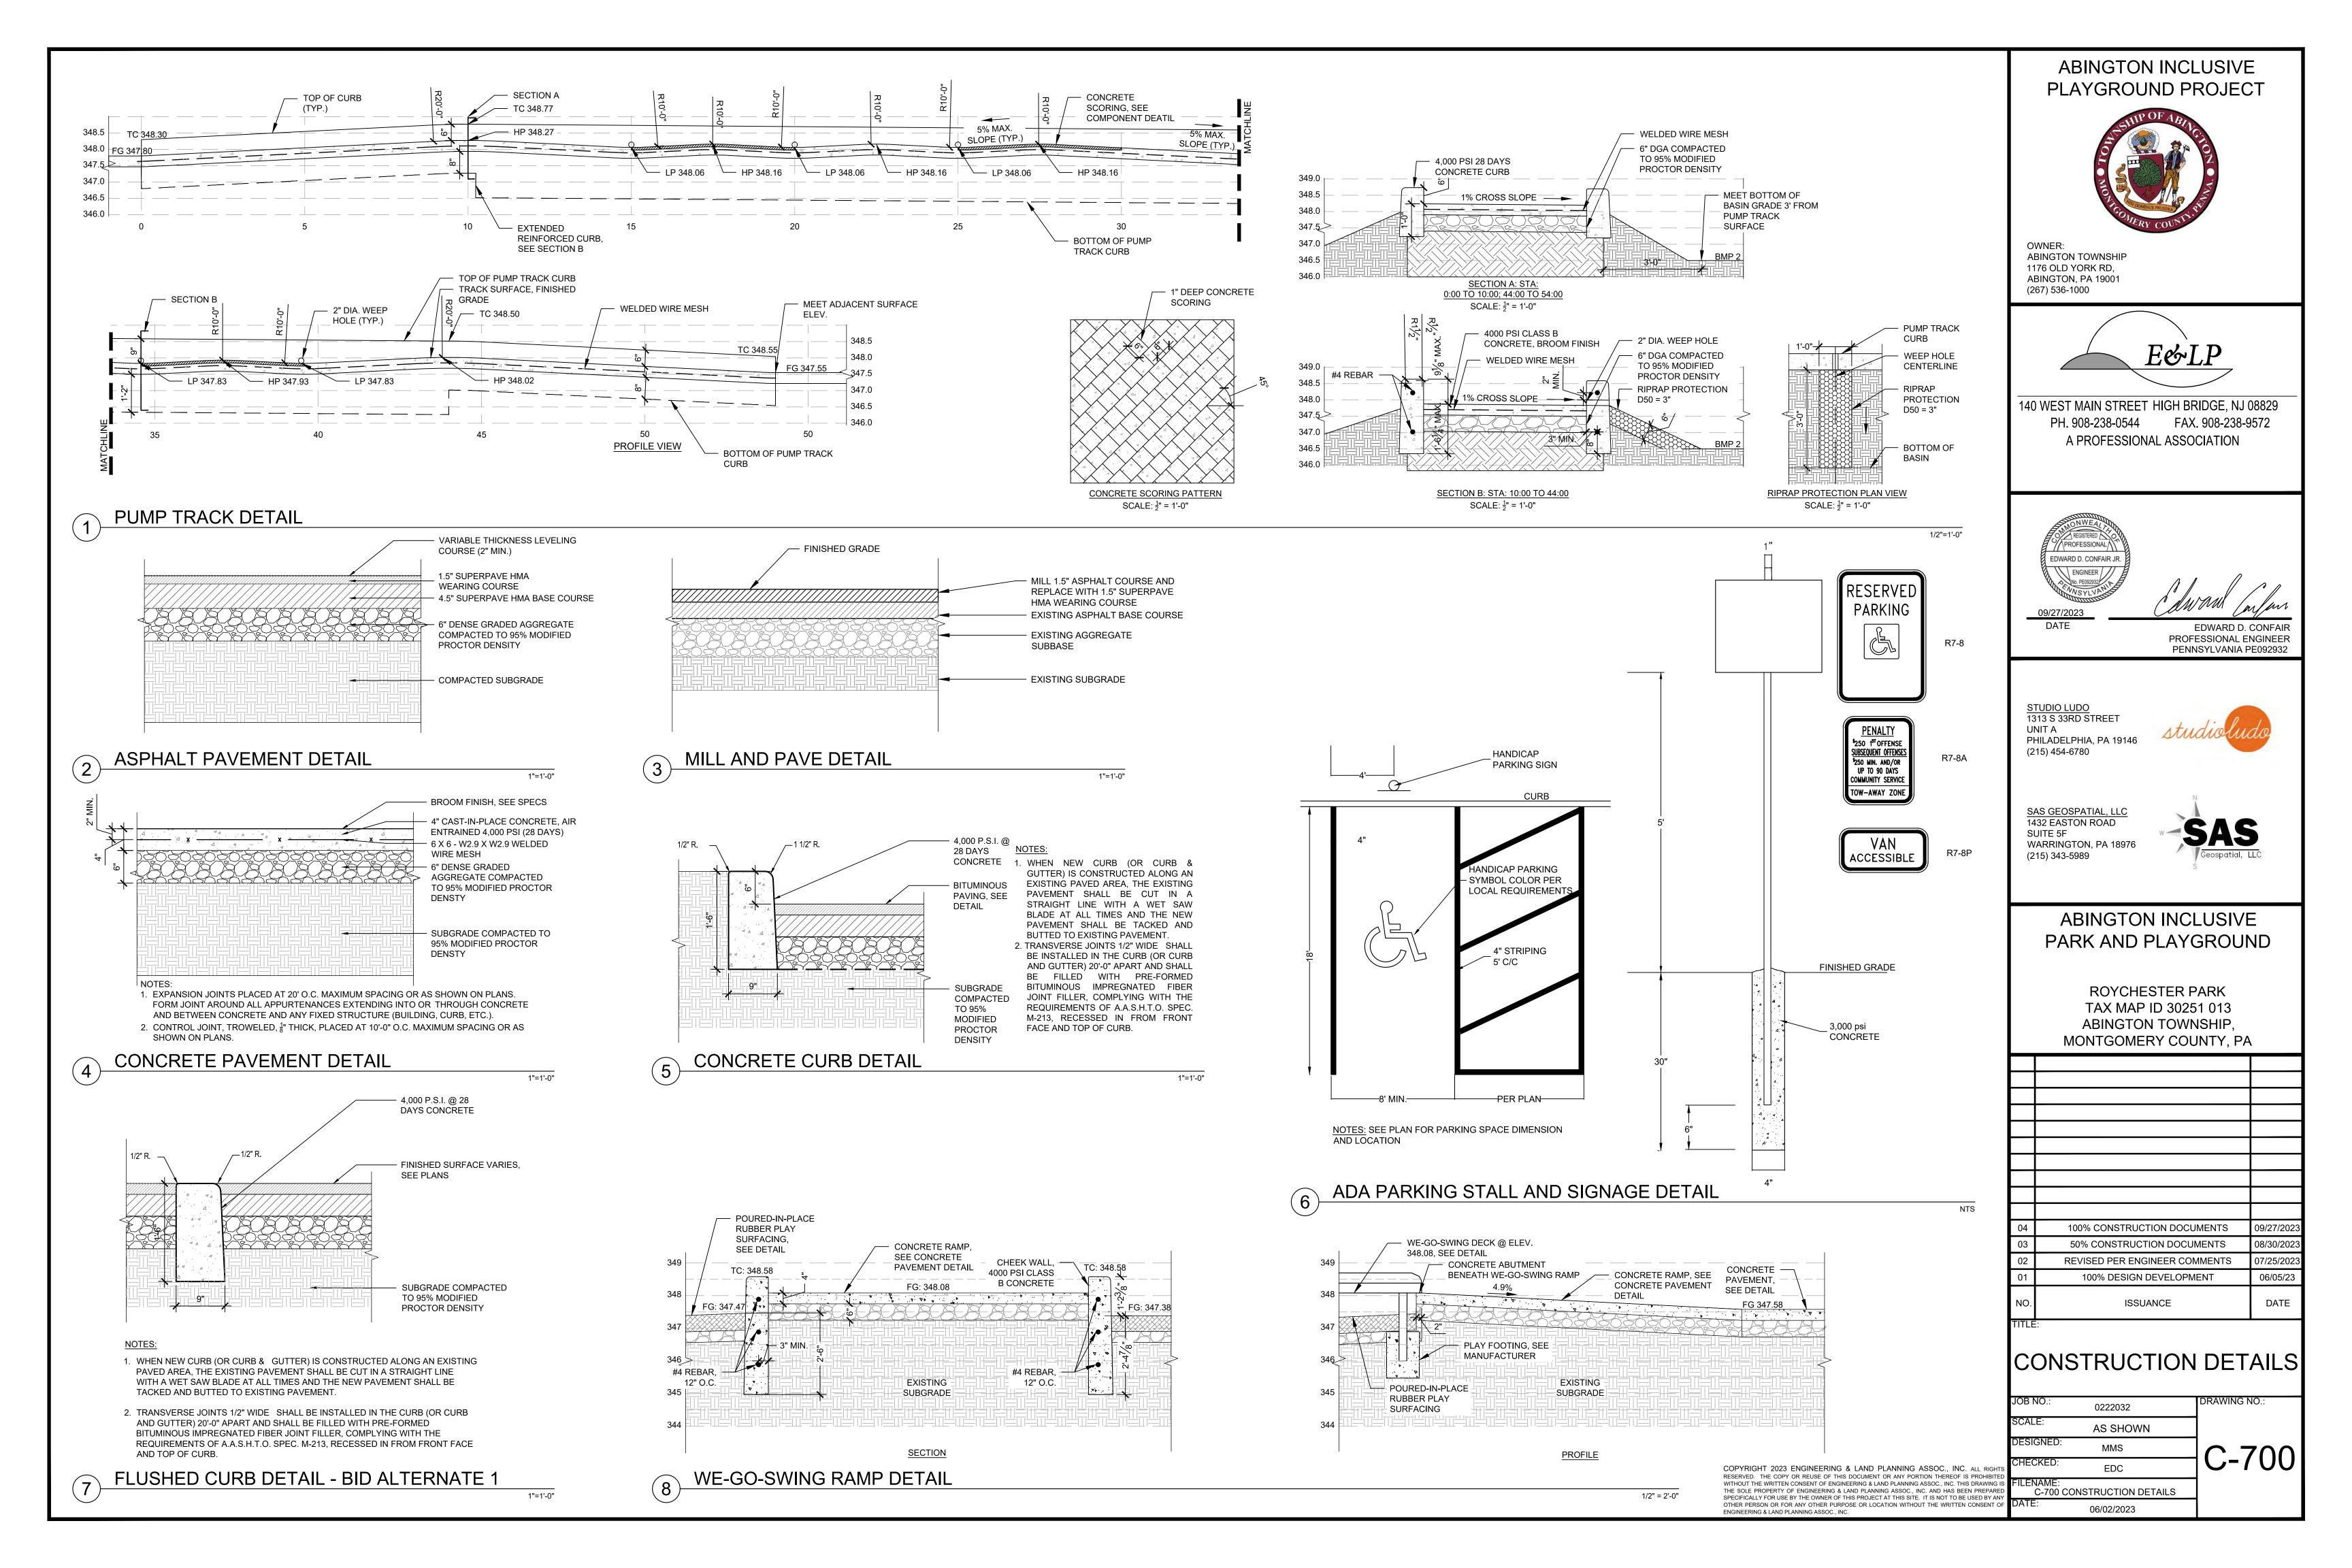WE-GO SWING DETAIL

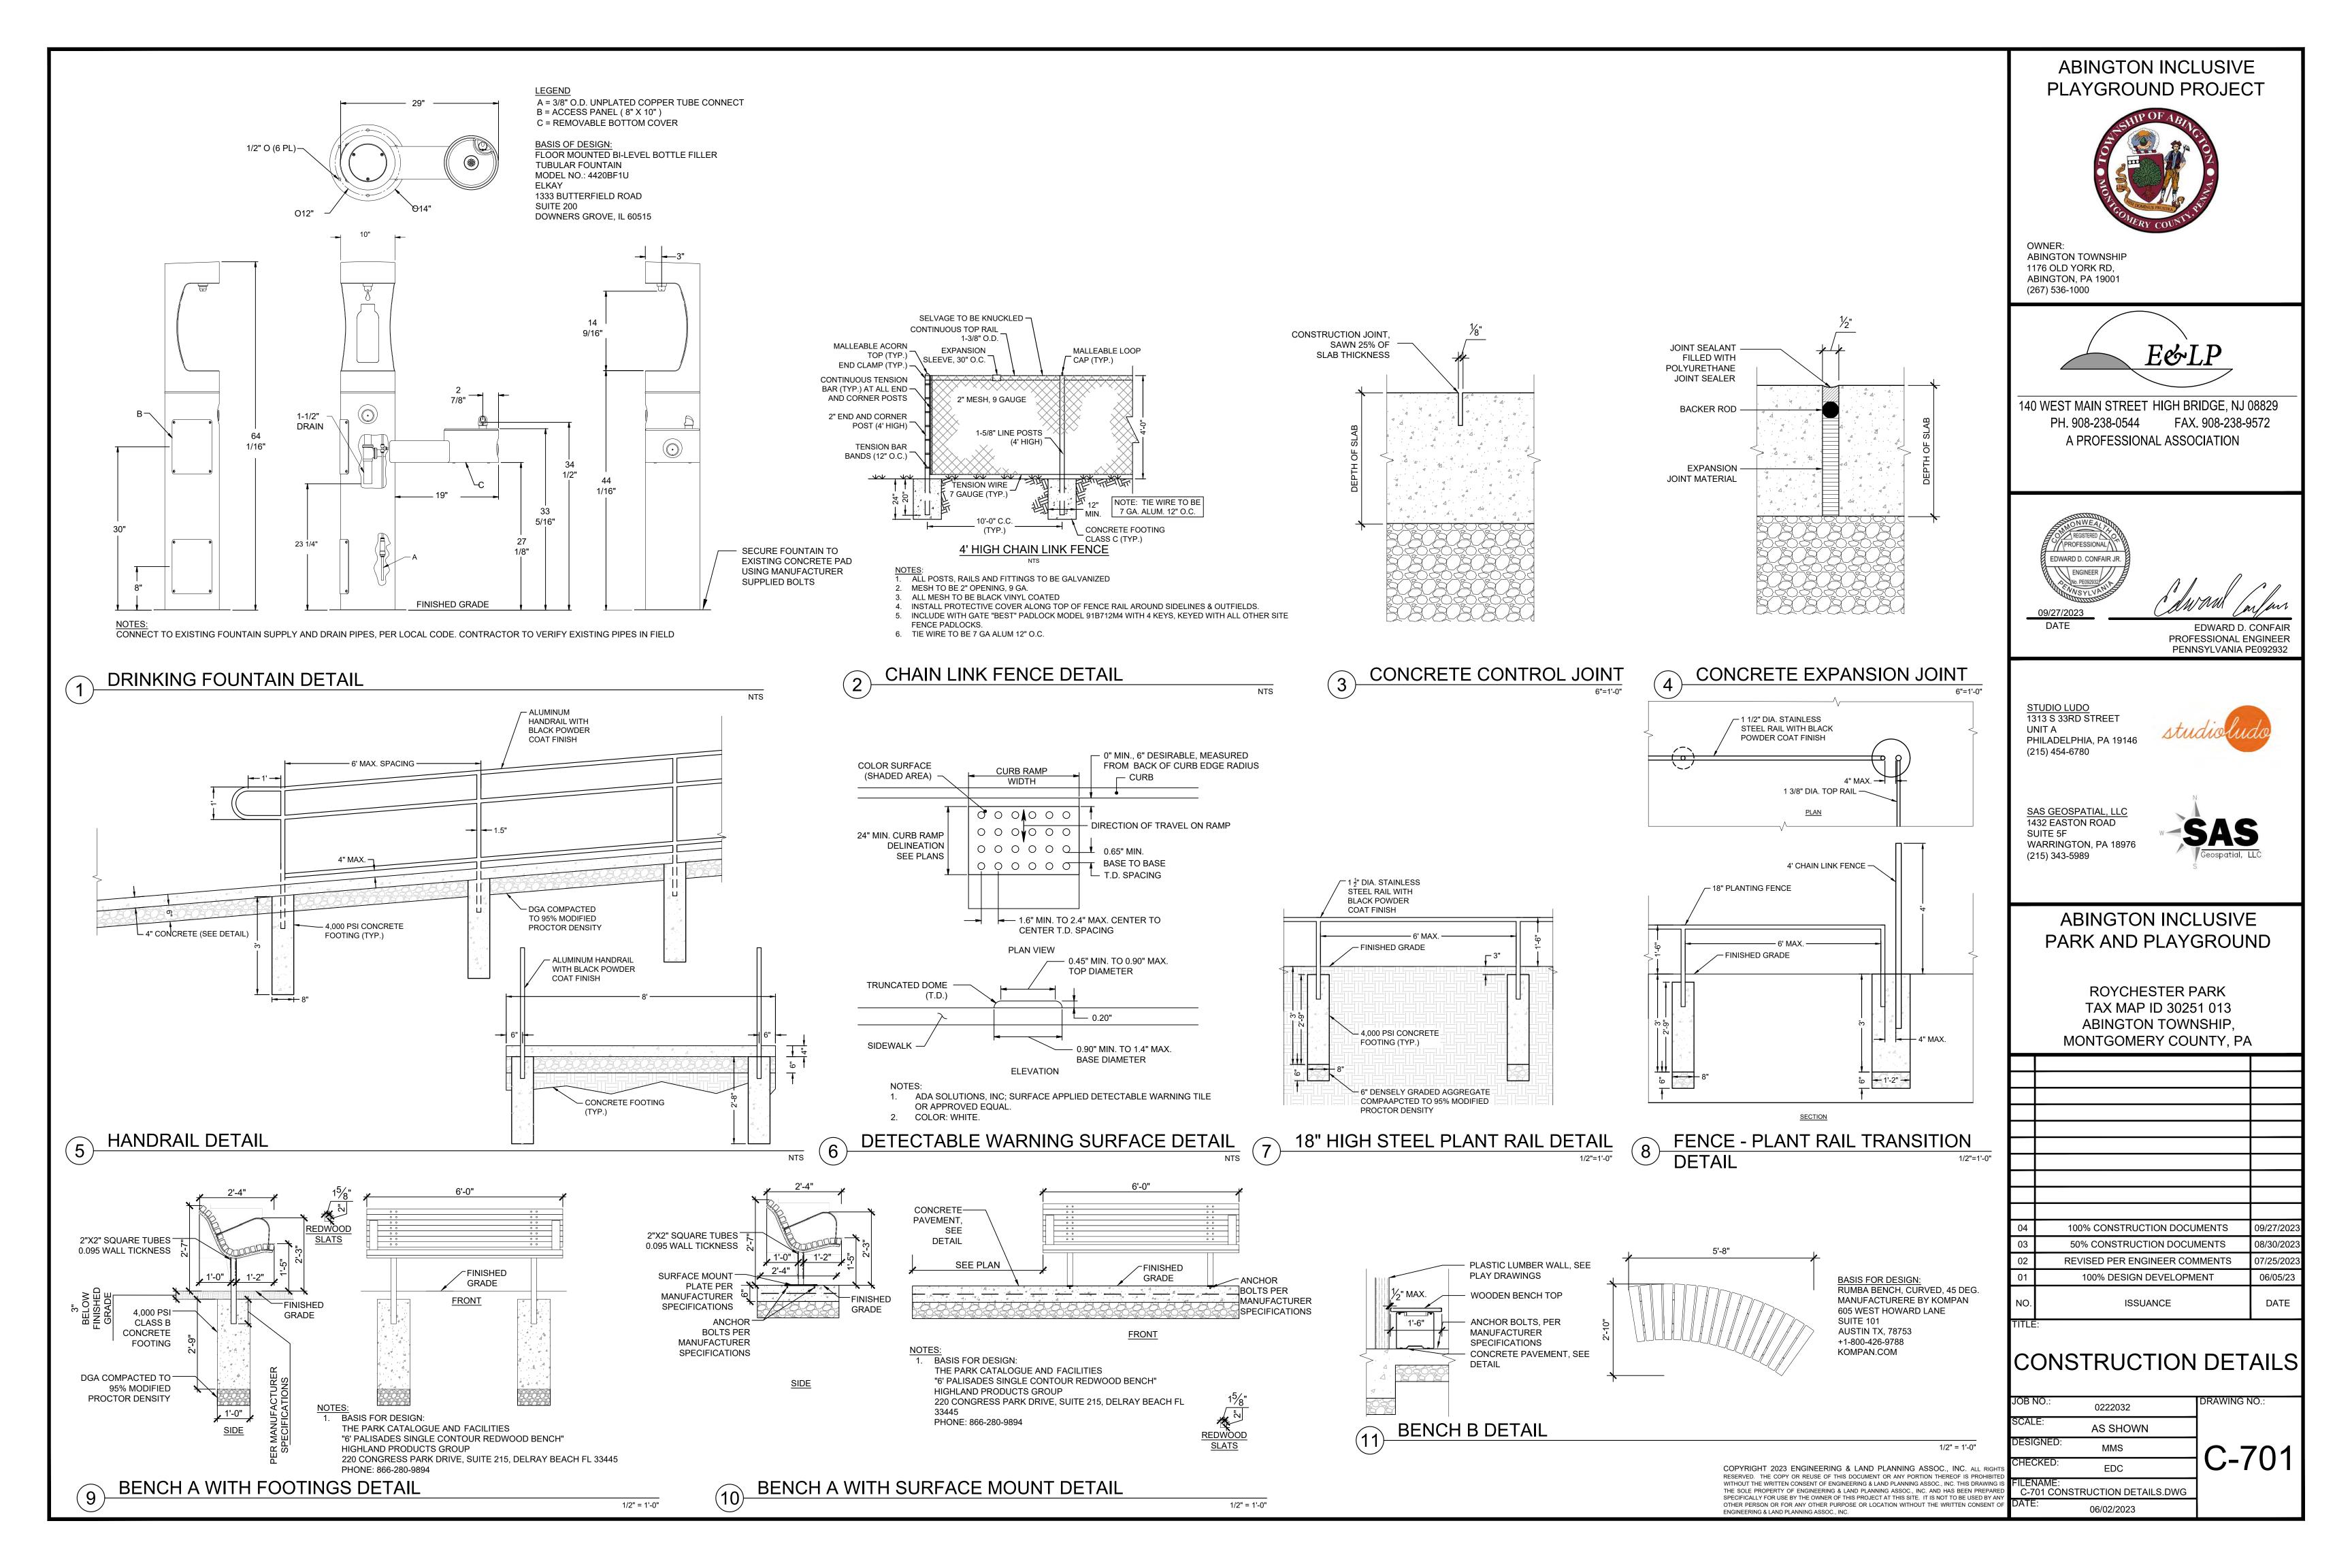1/2"=1'-0"

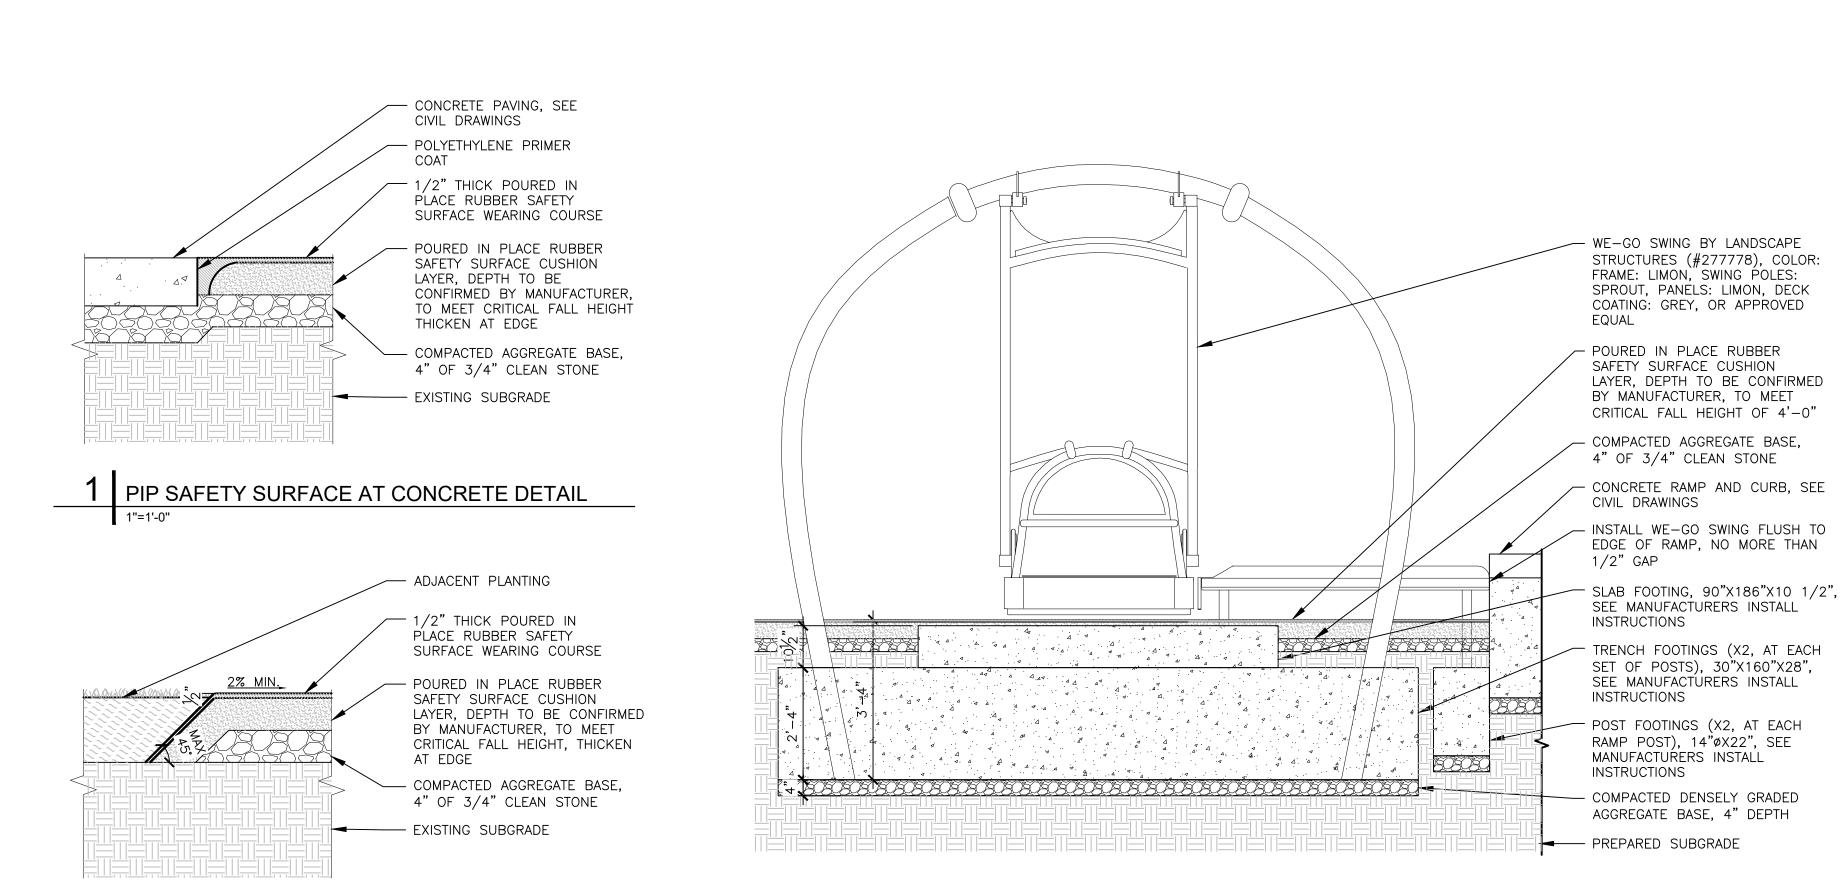

UNIVERSAL CAROUSEL DETAIL

1/2"=1'-0"

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OWNER:

ABINGTON TOWNSHIP

PH. 908-238-0544

1176 OLD YORK RD, ABINGTON, PA 19001

(267) 536-1000



MEGHAN TALAROWSKI

LA003356

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ABINGTON INCLUSIVE PARK AND PLAYGROUND

ABINGTON INCLUSIVE

PLAYGROUND PROJECT


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FAX. 908-238-9572

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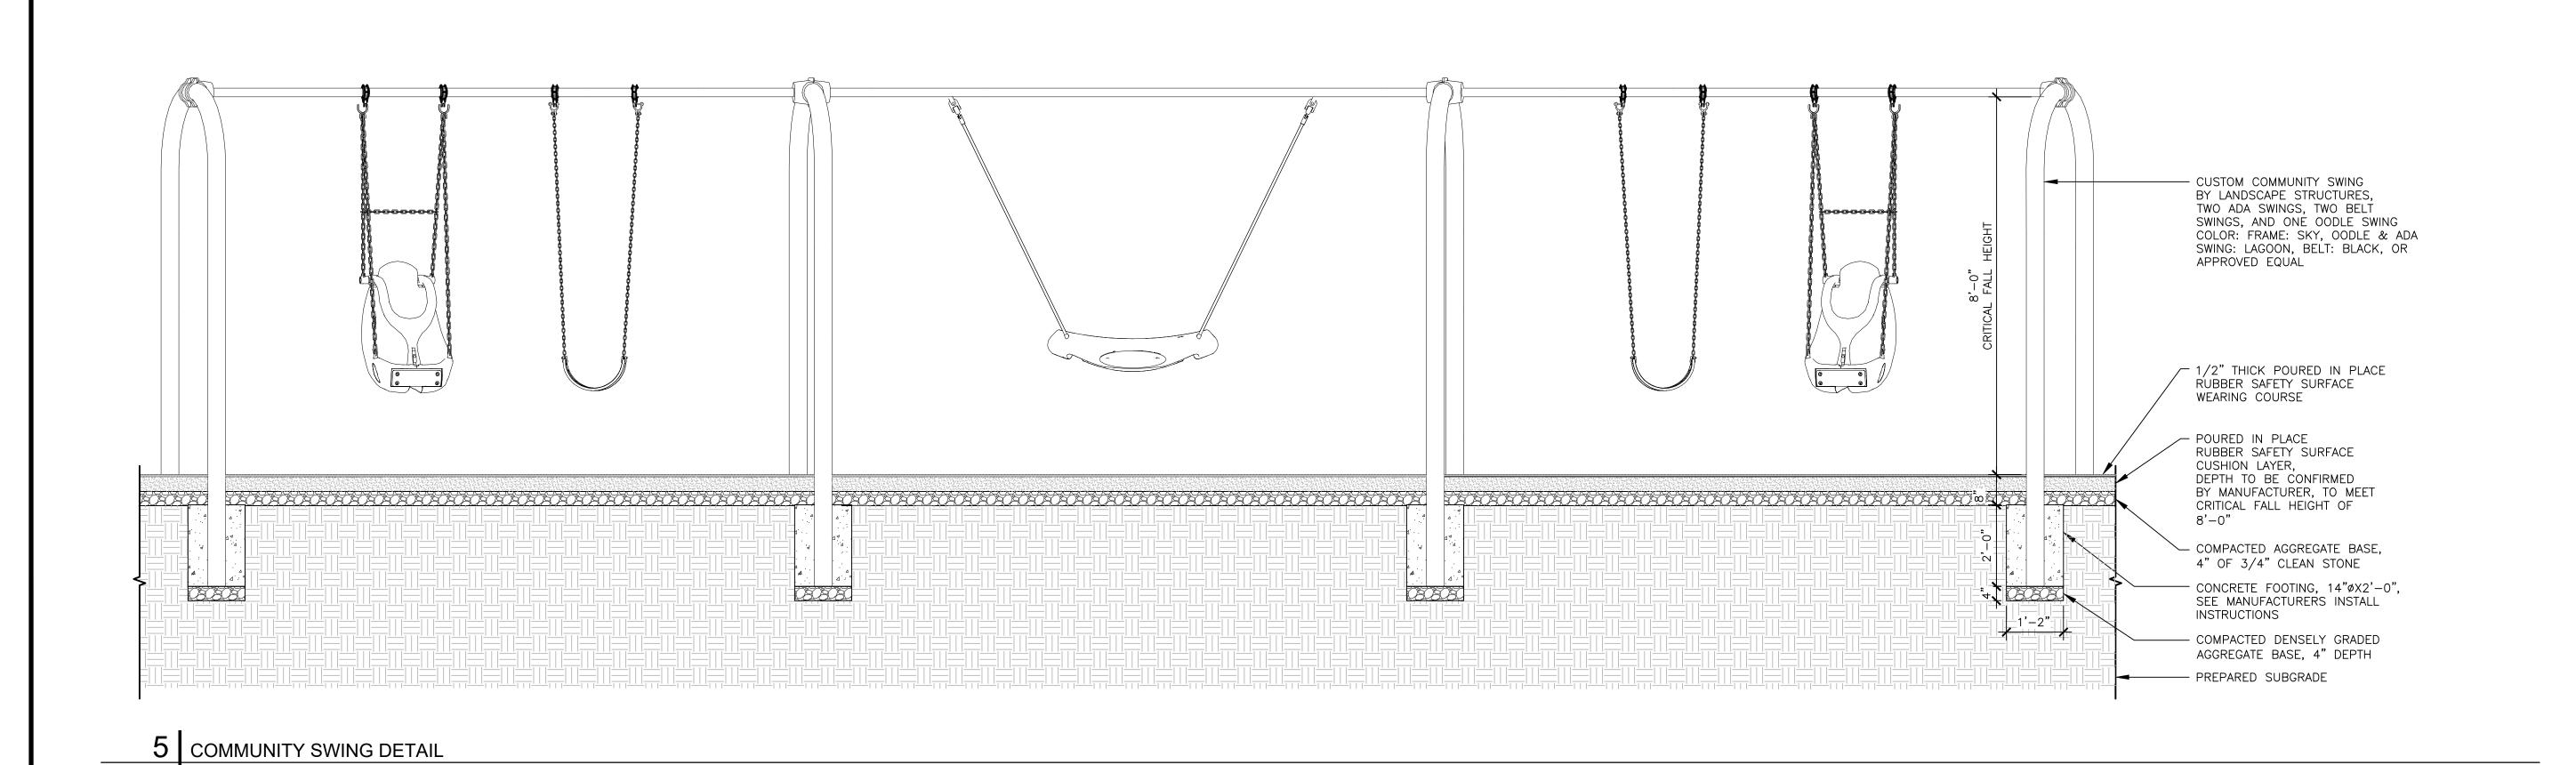
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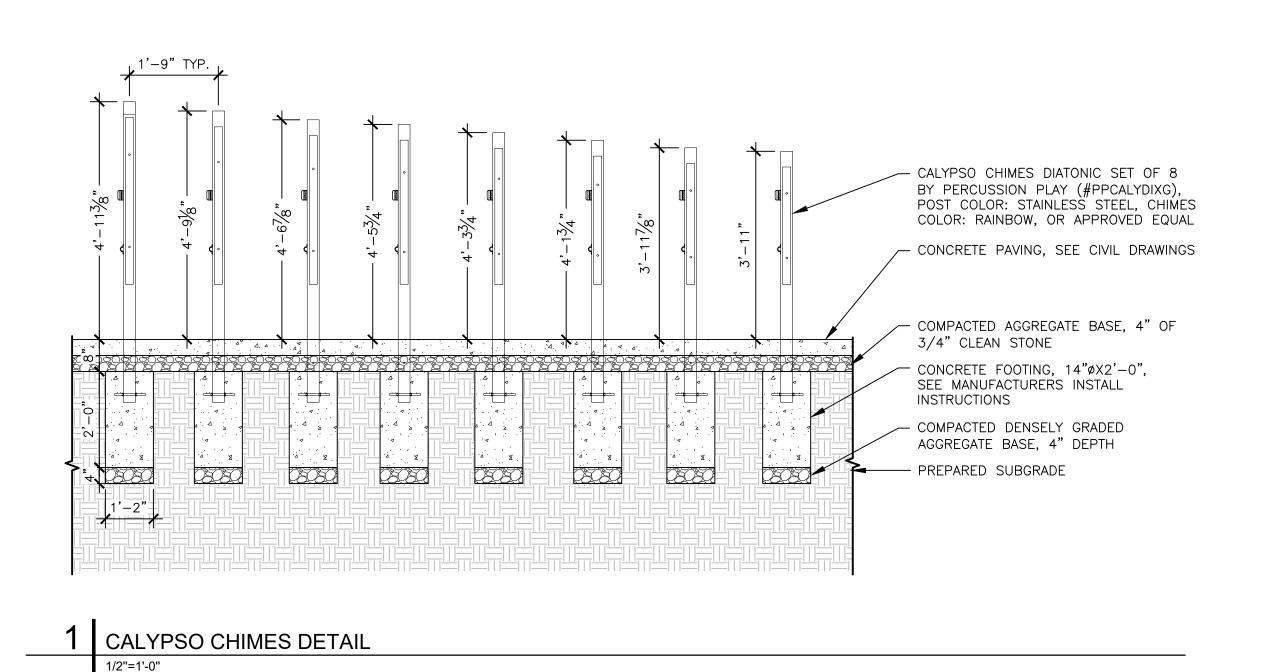
ROYCHESTER PARK TAX MAP ID 30251 013 ABINGTON TOWNSHIP, MONTGOMERY COUNTY, PA





PLAY DETAILS

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DESIGNED:	MT	PL-101
CHECKED:	MT	PL-101
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DATE:	09/27/23	

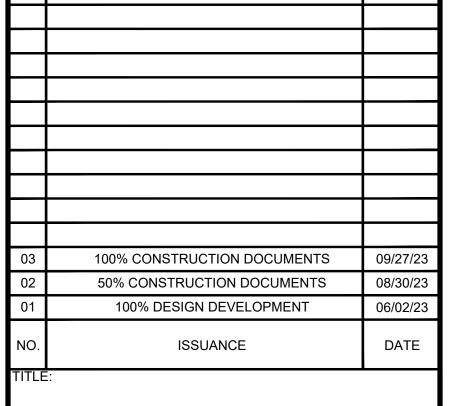





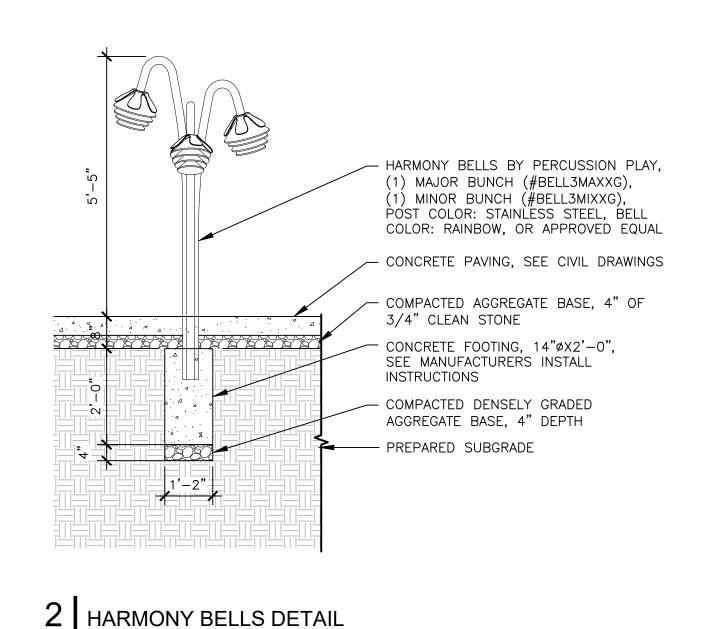

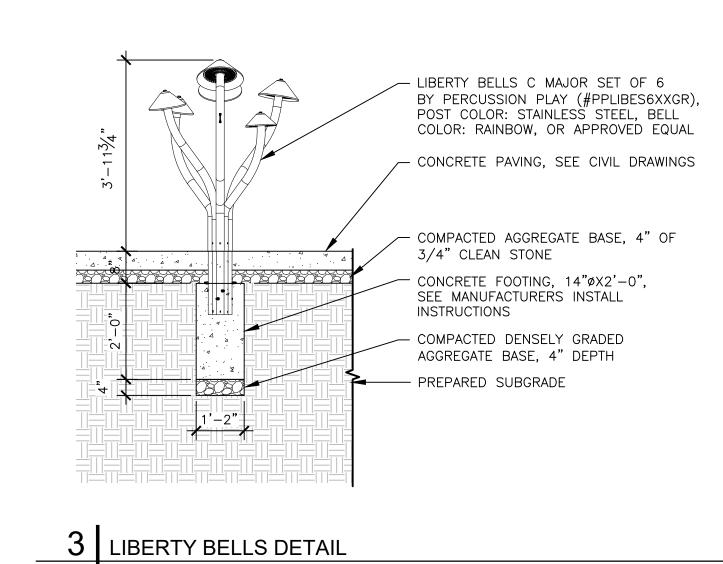

1/2"=1'-0"

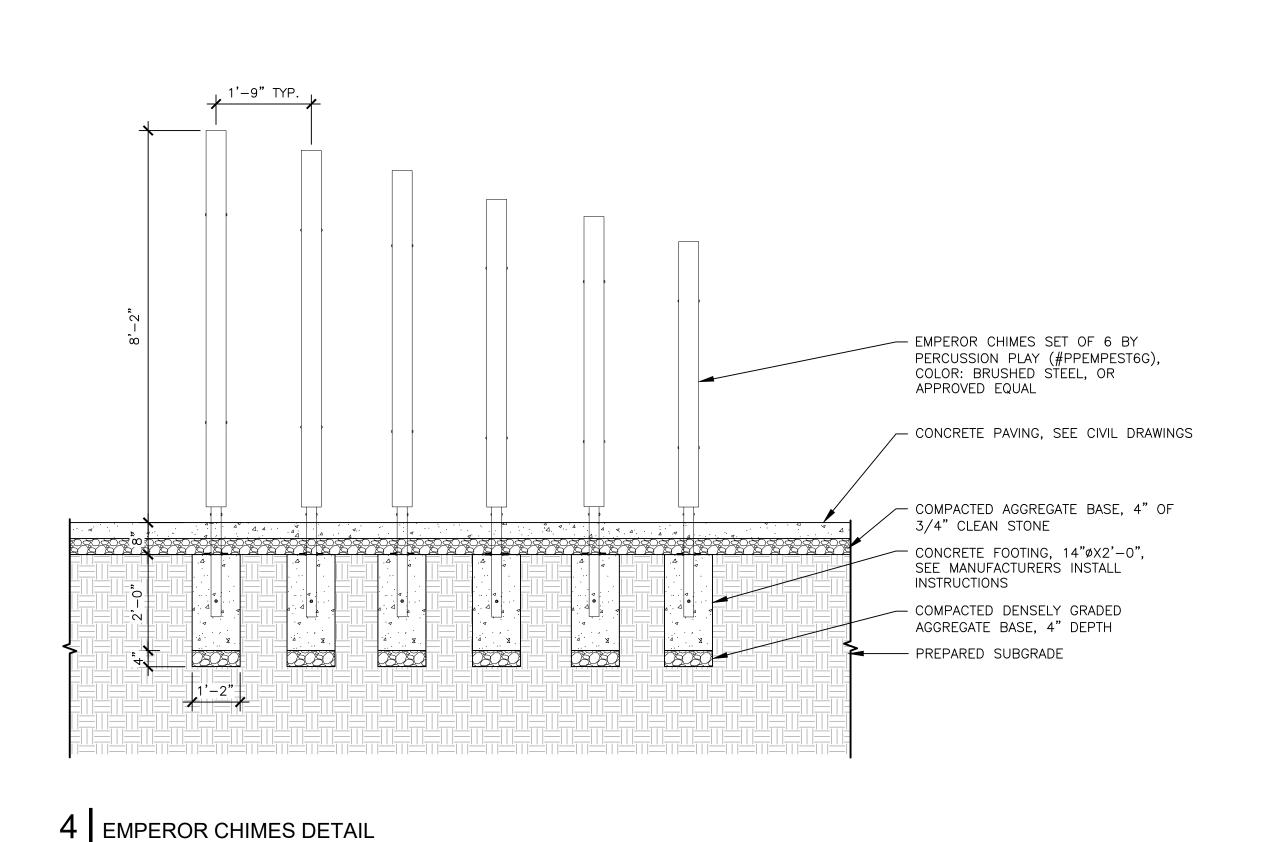

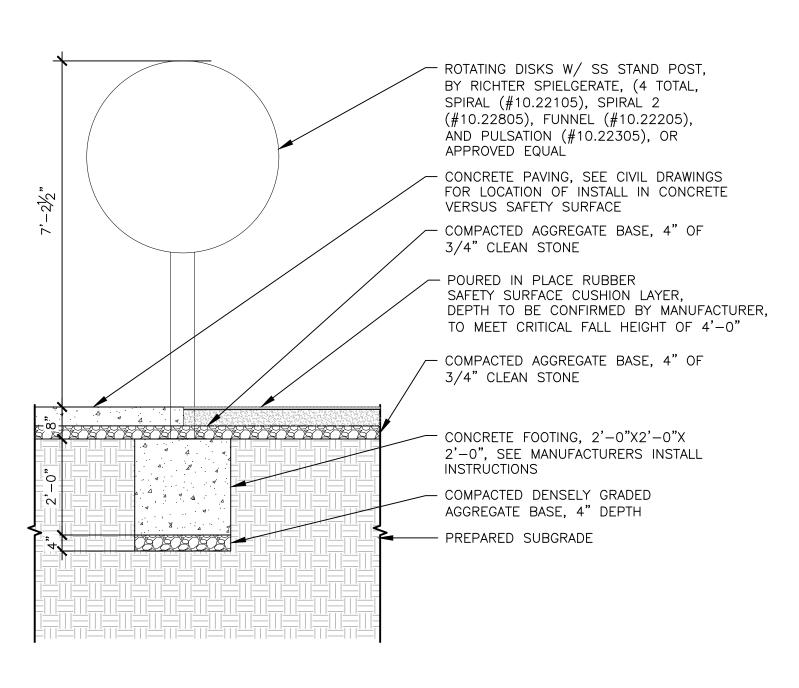

5 ROTATING DISKS DETAIL



080808

- 6"X6" RECYCLED PLASTIC DIMENSIONAL

LUMBER BY TANGENT SUSTAINABLE LUMBER, EQUAL PARTS PINK, TROPICAL

LIME GREEN, LEMON YELLOW, ARUBA BLUE, AND LIGHT GREY, RANDOMIZED, OR APPROVED EQUAL

- 1/2" THREADED SS ROD, INSET IN END

CONCRETE PAVING, SEE CIVIL DRAWINGS

— COMPACTED AGGREGATE BASE, 4" OF

CONCRETE FOOTING, 1-6" $\times 2$ '-0",

SEE MANUFACTURERS INSTALL
SEE PLAN DETAILS FOR LENGTHS

- COMPACTED DENSELY GRADED

AGGREGATE BASE, 4" DEPTH

OF POST, W/ ACORN CAP

─ 1/2" EXPANSION JOINT


3/4" CLEAN STONE

- PREPARED SUBGRADE

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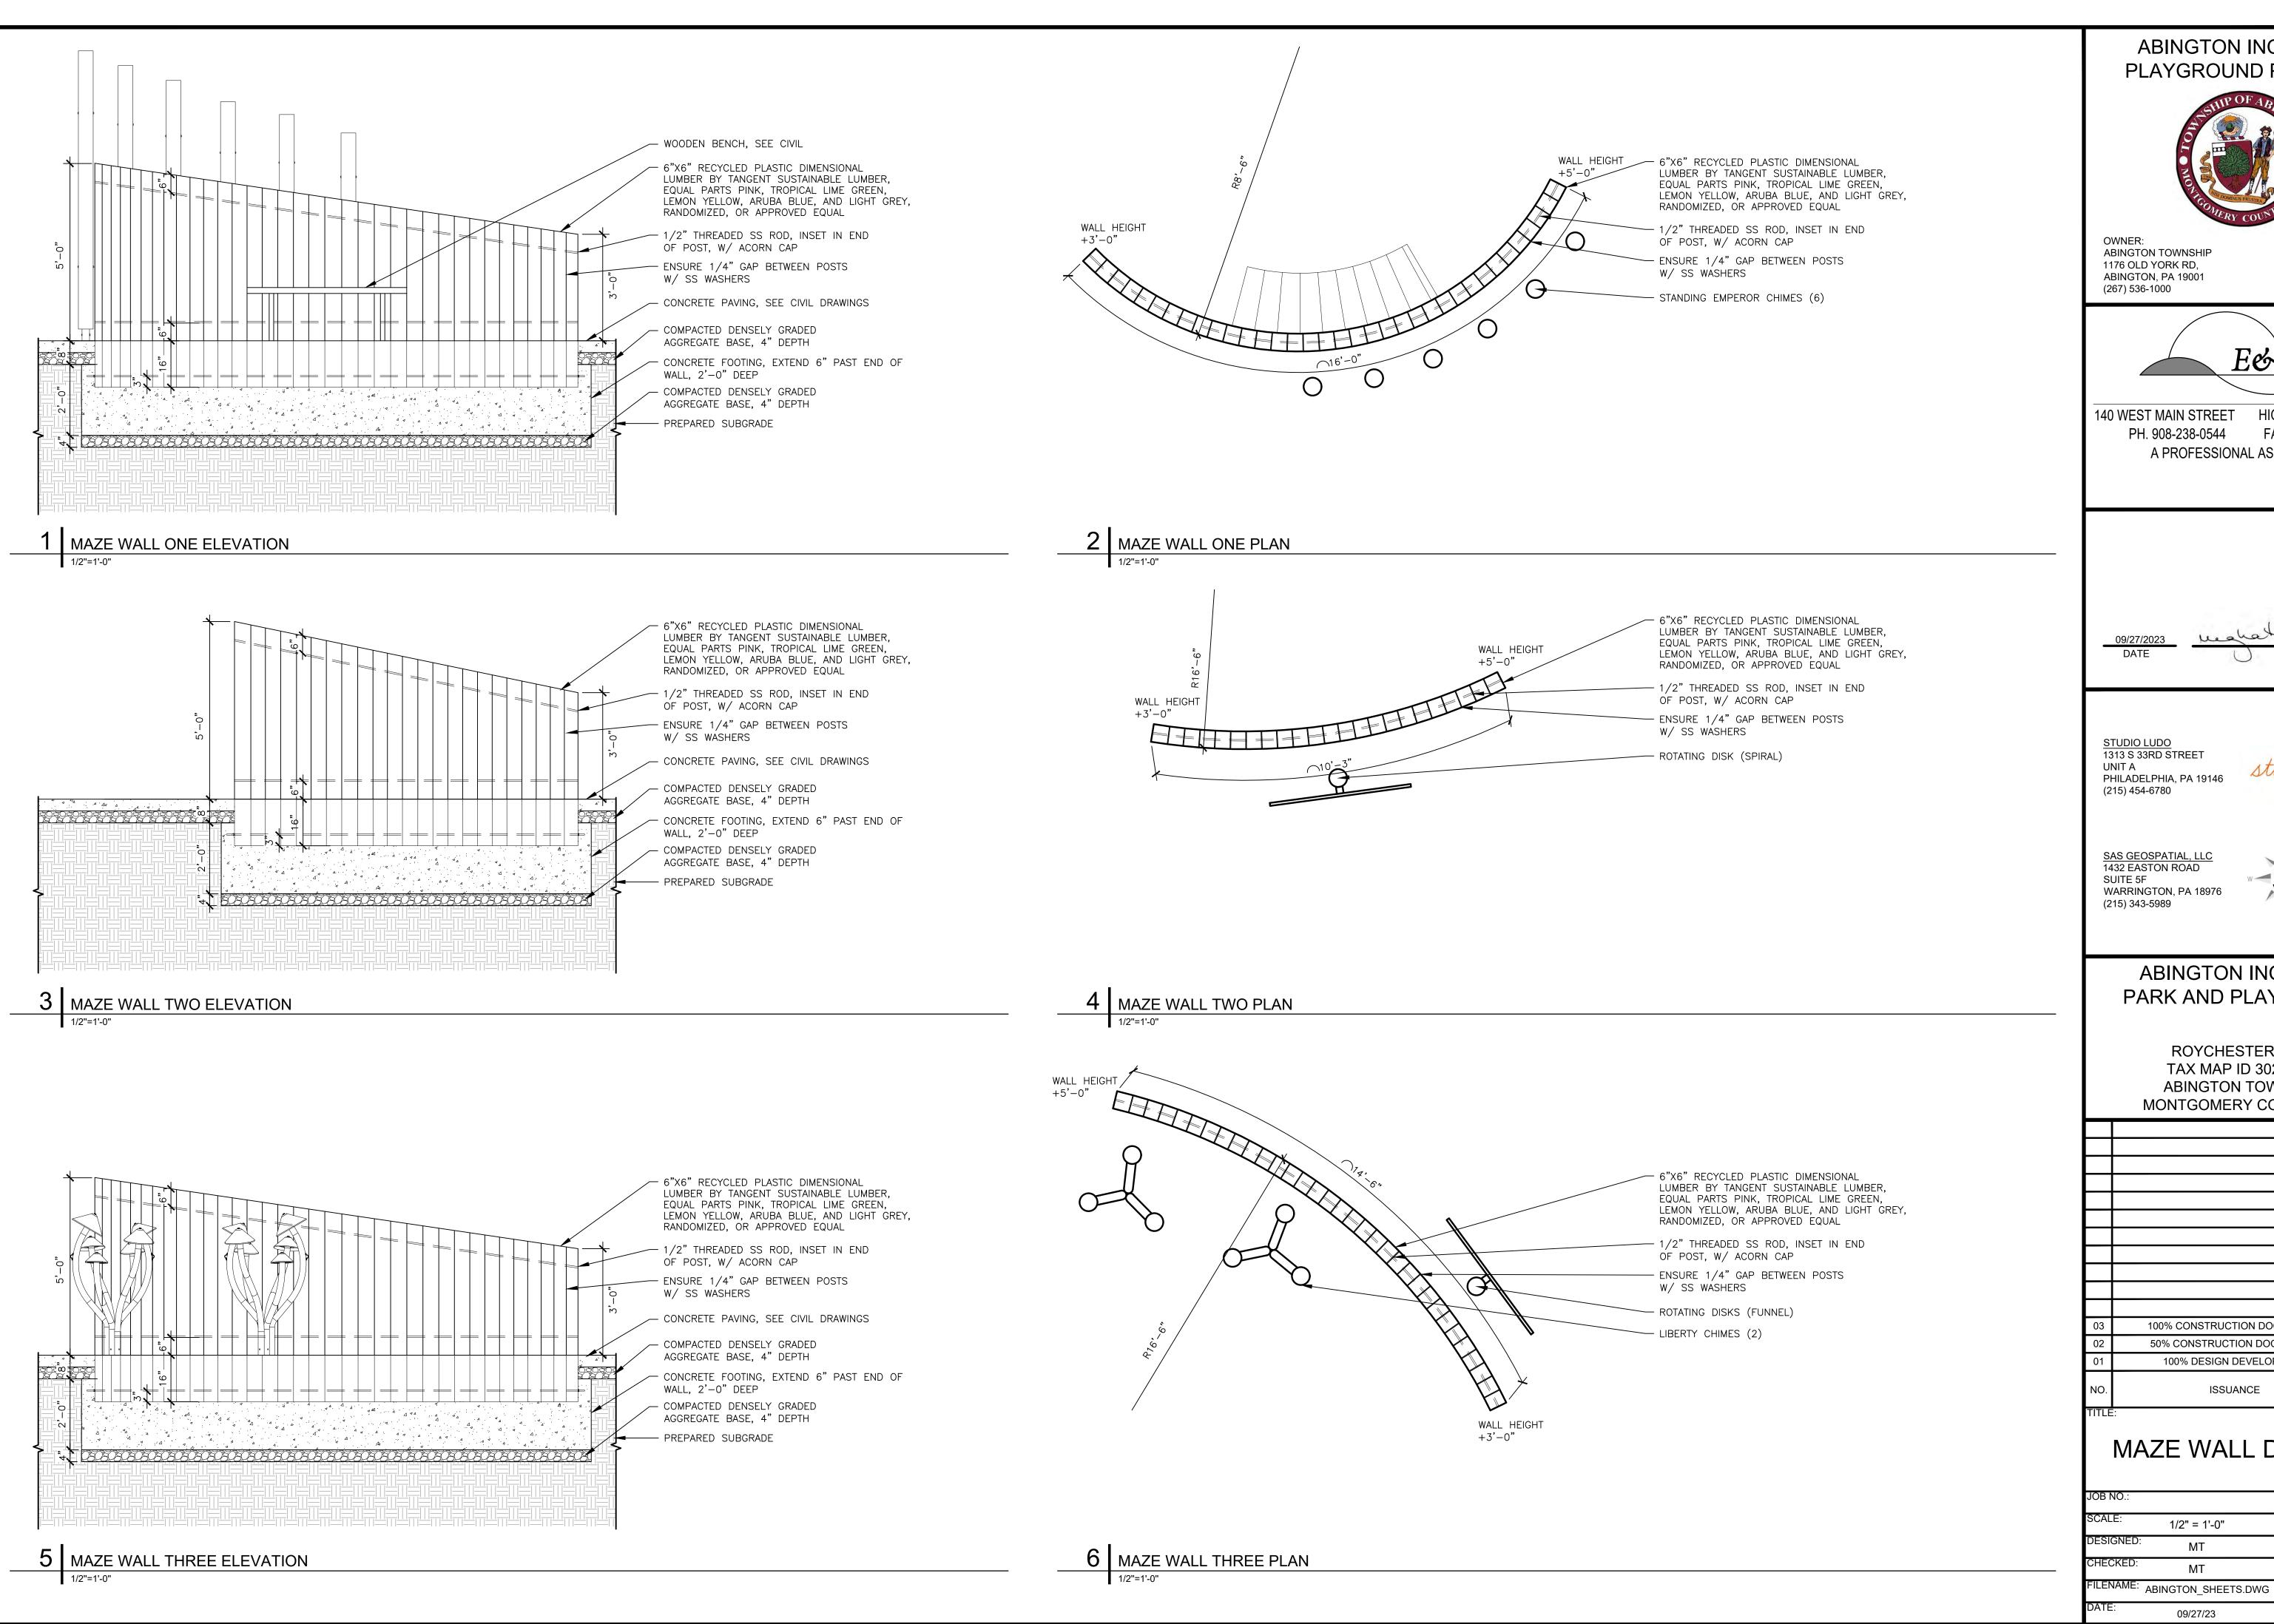
ABINGTON INCLUSIVE PARK AND PLAYGROUND

ROYCHESTER PARK TAX MAP ID 30251 013 ABINGTON TOWNSHIP, MONTGOMERY COUNTY, PA

03	100% CONSTRUCTION DOCUMENTS	09/27/23
02	50% CONSTRUCTION DOCUMENTS	08/30/23
01	100% DESIGN DEVELOPMENT	06/02/23
NO.	ISSUANCE	DATE
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PLAY DETAILS

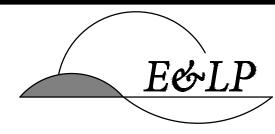JOB NO.:			DRAWING NO.:
SCALE:	1/2" = 1'-0"		
DESIGNED:	MT		DI 102
CHECKED:	MT		PL-102
FILENAME: A	BINGTON_SHEETS.	OWG	
DATE:	00/07/00		



ABINGTON INCLUSIVE PLAYGROUND PROJECT



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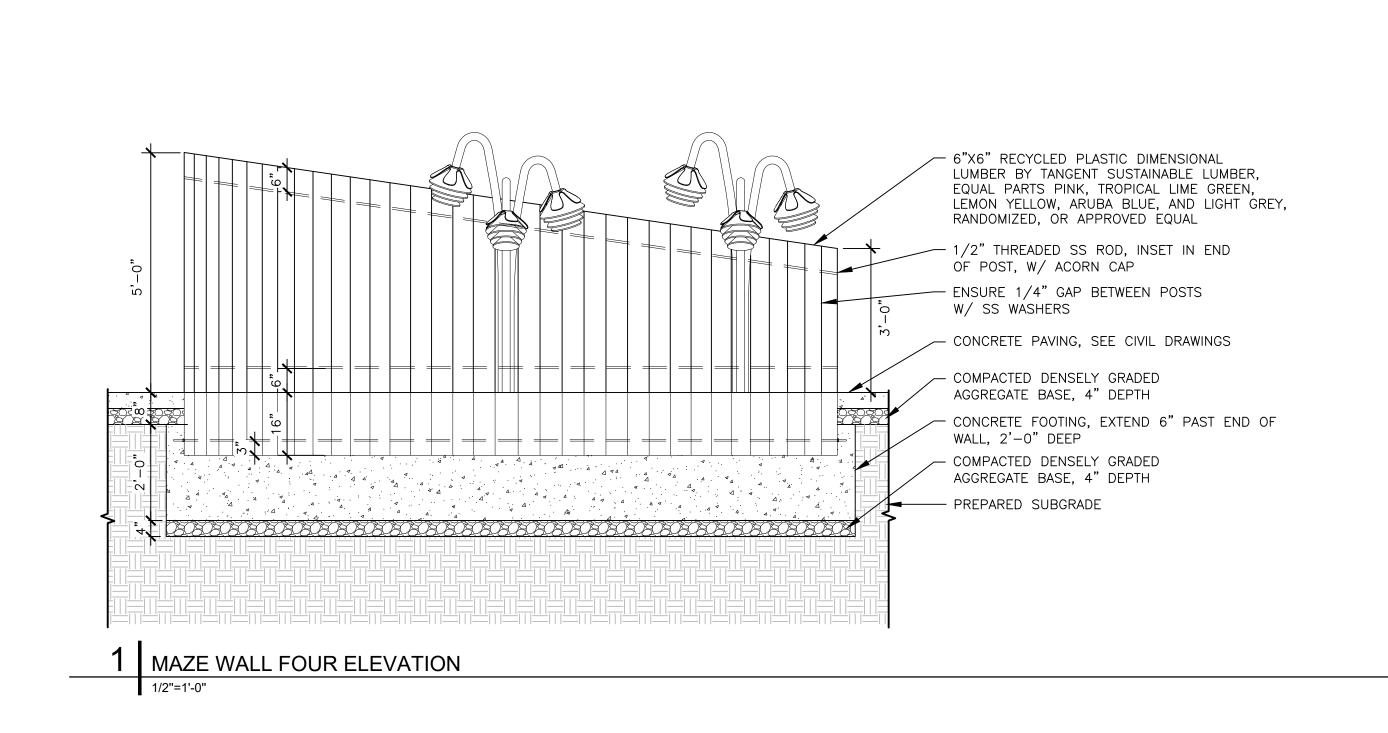
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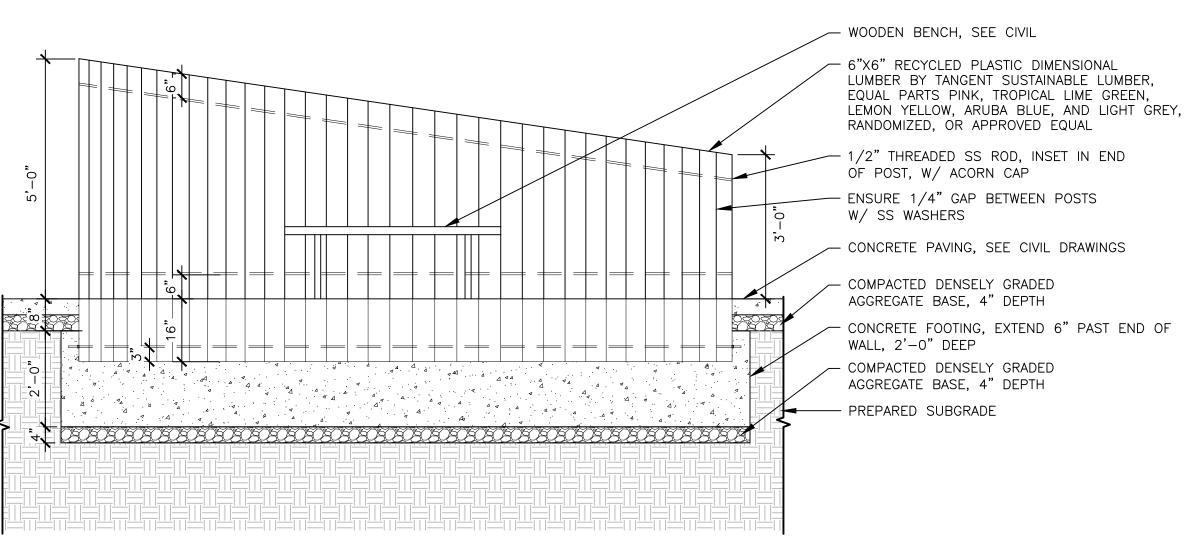
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NO.	ISSUANCE	DATE
TITLE	:	

MAZE WALL DETAILS


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09/27/23






3 MAZE WALL FIVE ELEVATION

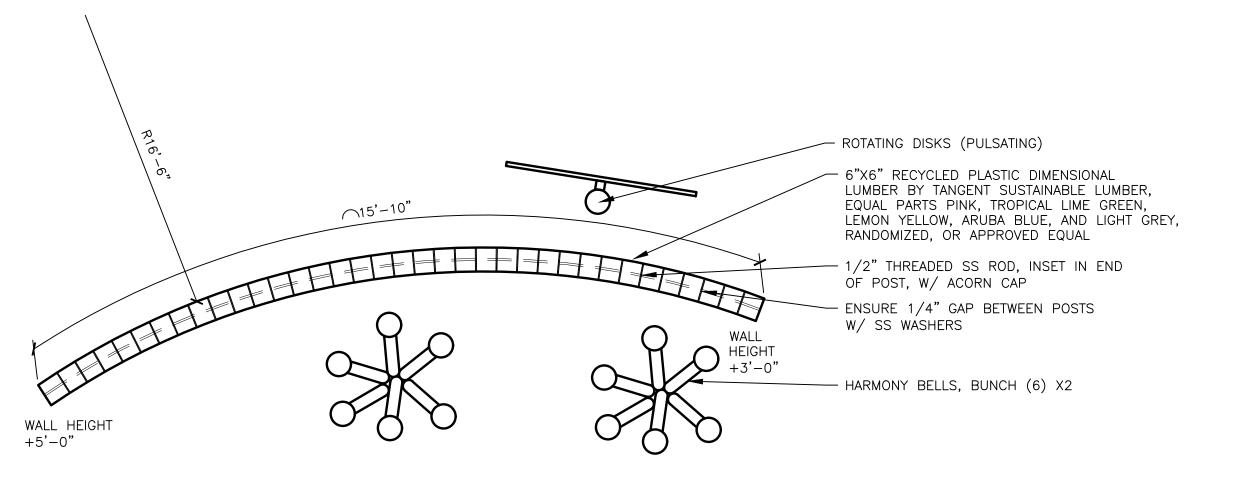

2 MAZE WALL FOUR PLAN

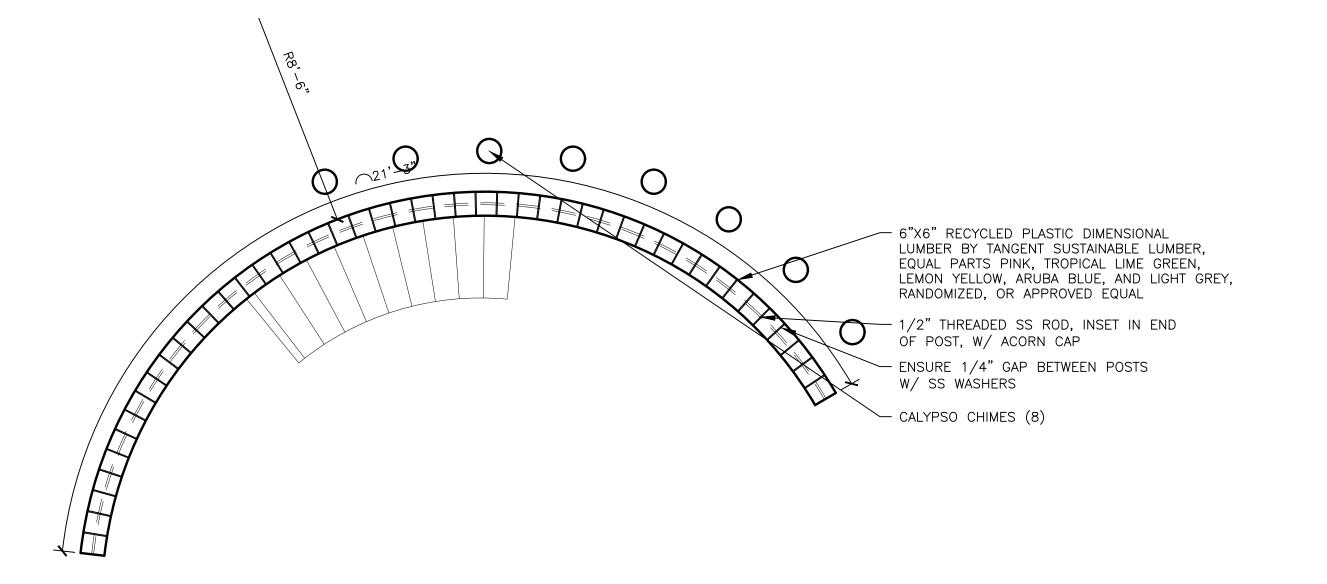


4 MAZE WALL FIVE PLAN

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ABINGTON INCLUSIVE PARK AND PLAYGROUND

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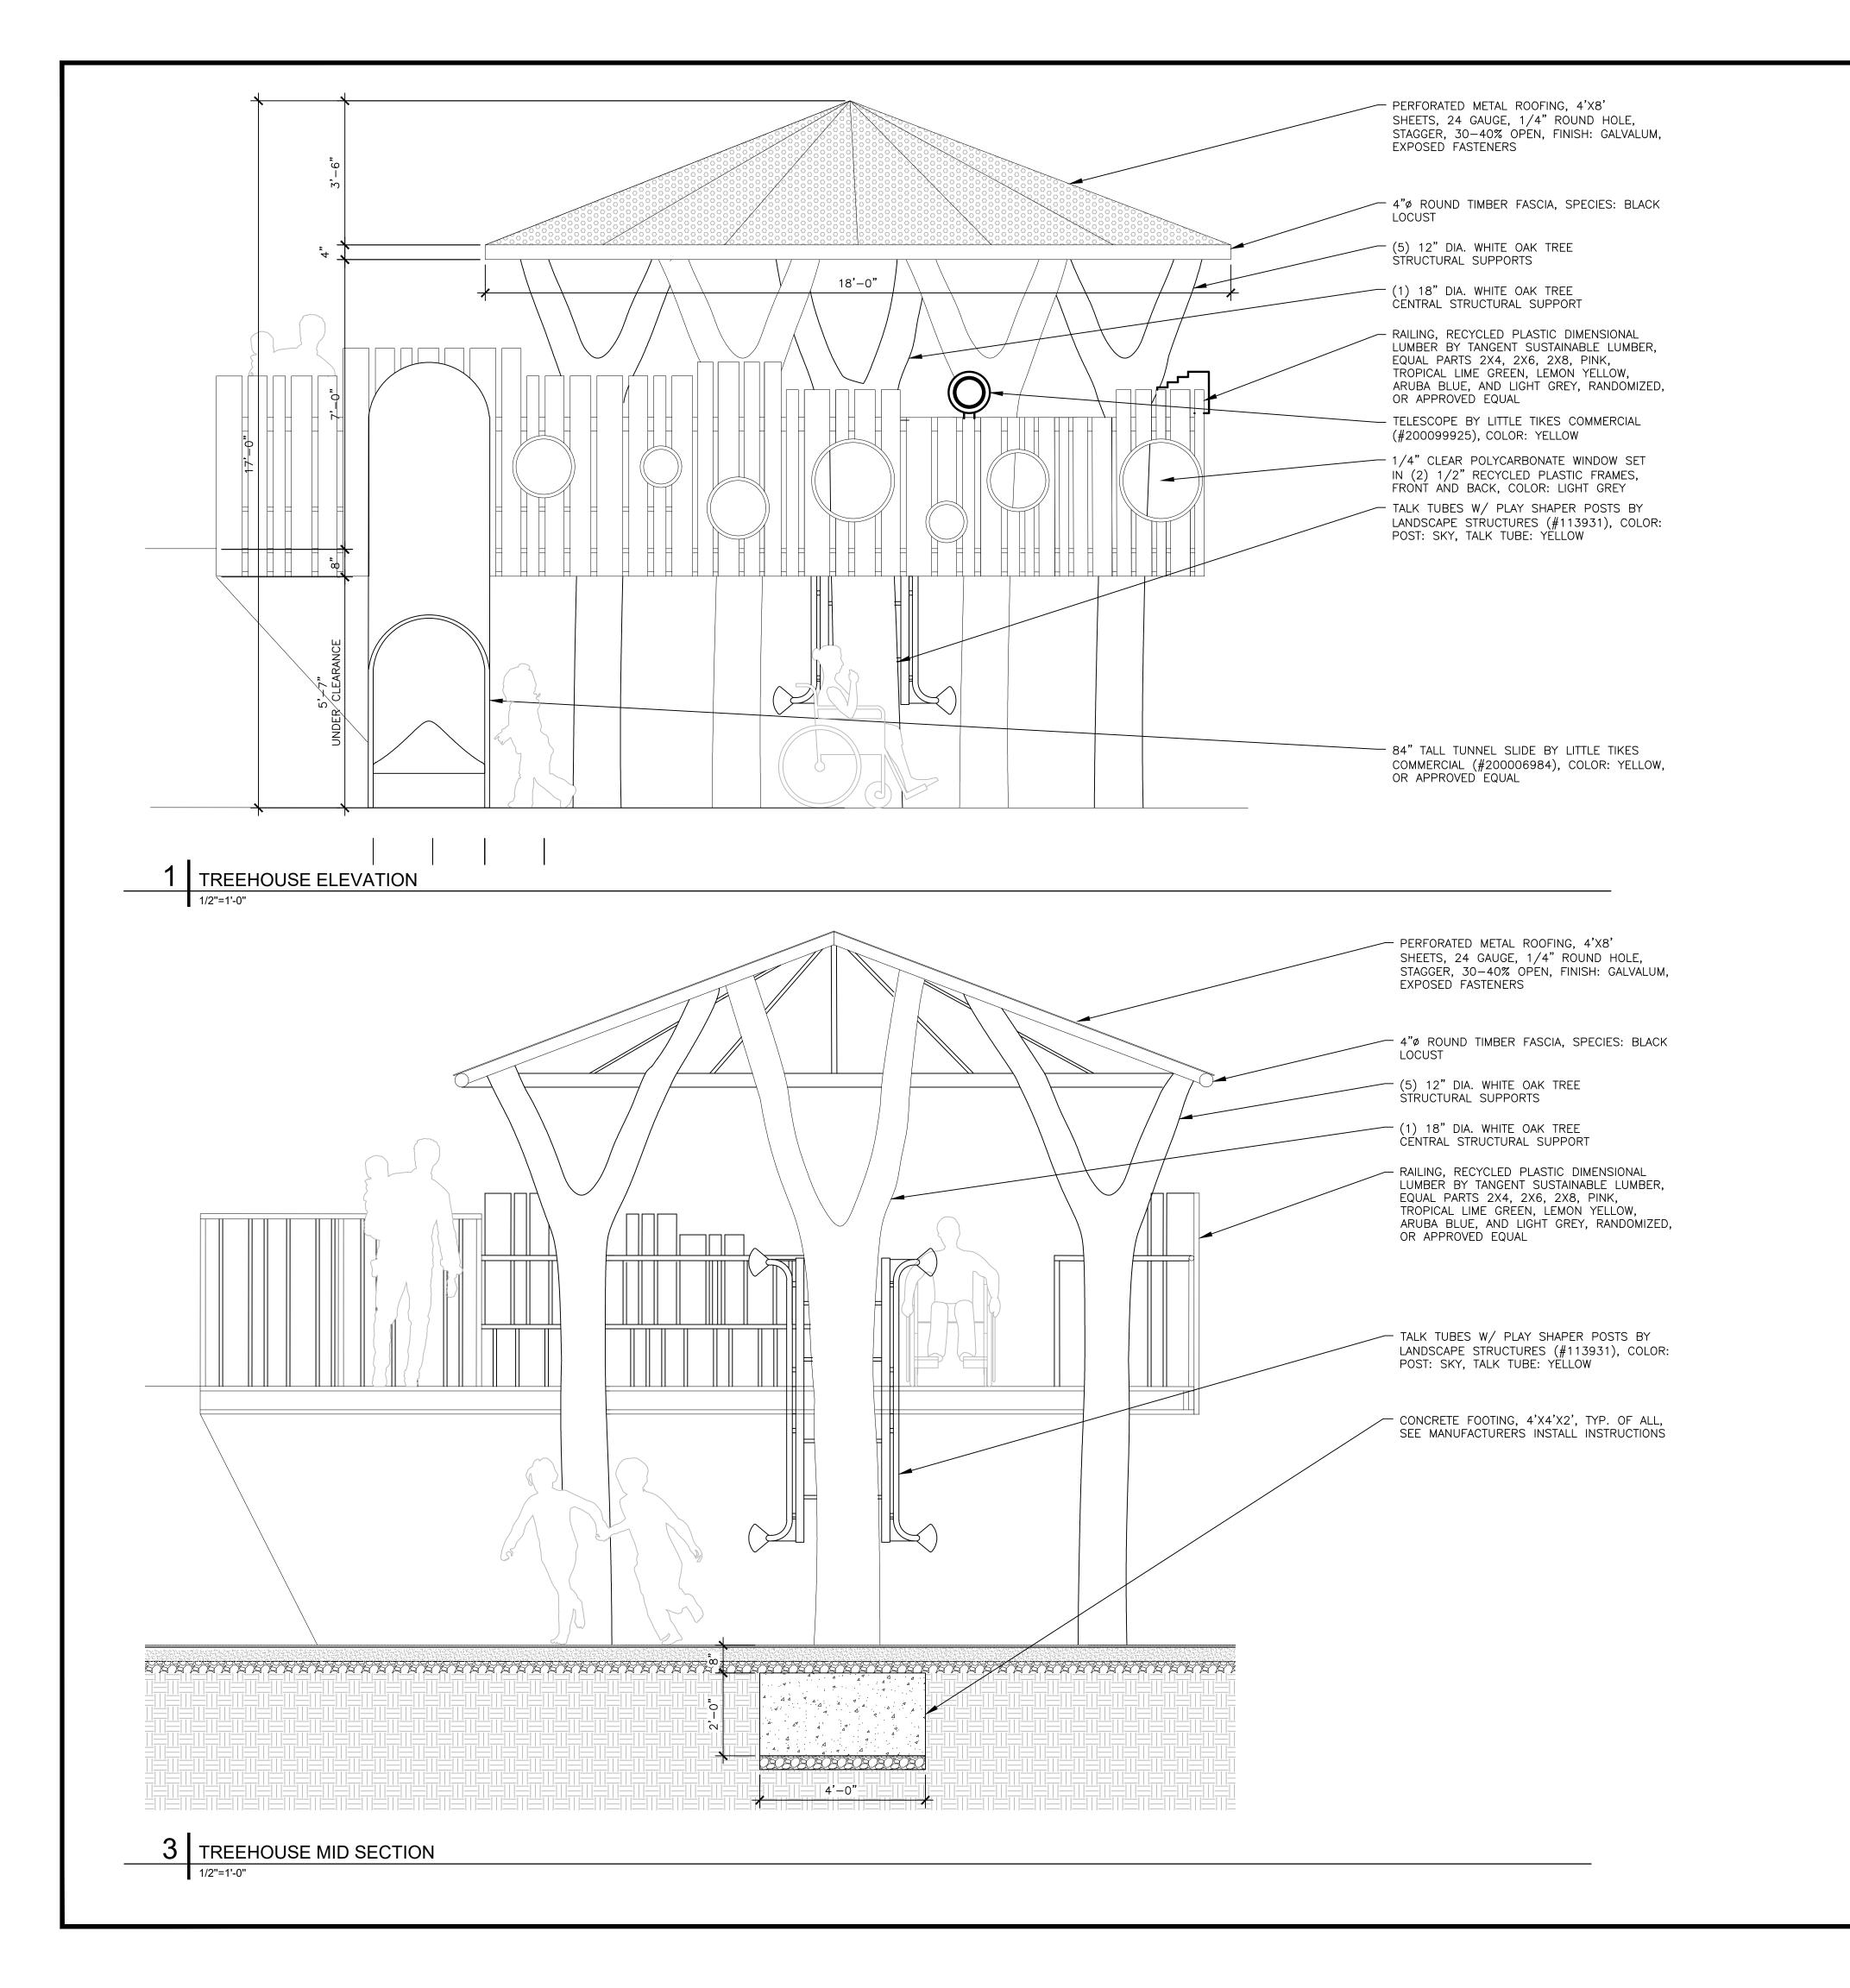
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03	100% CONSTRUCTION DOCUMENTS	09/27/23
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01	100% DESIGN DEVELOPMENT	06/02/23
NO.	ISSUANCE	DATE
TITLE	:	

MAZE WALL DETAILS

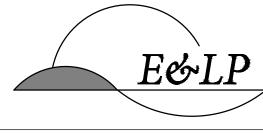1/4" = 1'-0" MT CHECKED:

09/27/23

∤PL-104**|** FILENAME: ABINGTON_SHEETS.DWG



TREEHOUSE NOTES

COMPONENT PARTS OF TREEHOUSE EXCEPT ENCLOSURE (ROOFING AND RAILING)

2. OTHER VENDOR TO PROVIDE AND

3. WHOLE TREE TO PROVIDE AND COORDINATE ALL TREEHOUSE PLAY COMPONENTS

4. WHOLE TREES TO PROVIDE ALL TECHNICAL DRAWINGS (INCLUDING FOR PERMIT, STAMPED BY LICENSED STRUCTURAL ENGINEER IN PA), STRUCTURAL ASSESSMENT, MÉMBER AND FOOTING SIZING

5. LANDSCAPE ARCHITECT TO APPROVE TECHNICAL DRAWINGS PRIOR TO FABRICATION

6. WHOLE TREES TO PROVIDE FULLY FABRICATED TREEHOUSE PARTS AND INSTALL INSTRUCTIONS DELIVERED TO SITE

7. WHOLE TREE TO PROVIDE OFF SITE STORAGE FOR UP TO 8 WEEKS AS NEEDED FOR TREEHOUSE PRIOR TO INSTALL

8. WHOLE TREES TO PROVIDE TECHNICAL SUPPORT AND GUIDANCE DURING INSTALLATION AND PROVIDE SUPPLEMENTAL INSTRUCTIONS AS NEEDED

9. AN APPROVED EQUAL TO WHOLE TREES IS ALLOWABLE, PROVIDED THE VENDOR AND PRODUCTS ARE MATERIALLY SIMILAR AND OF THE QUALITY DEFINED IN THE SPECIFICATION SECTION 116813

1. WHOLE TREES TO PROVIDE ALL

INSTALL ROOFING AND RAILING

OWNER:

ABINGTON, PA 19001 (267) 536-1000



ABINGTON TOWNSHIP

1176 OLD YORK RD,

ABINGTON INCLUSIVE

PLAYGROUND PROJECT

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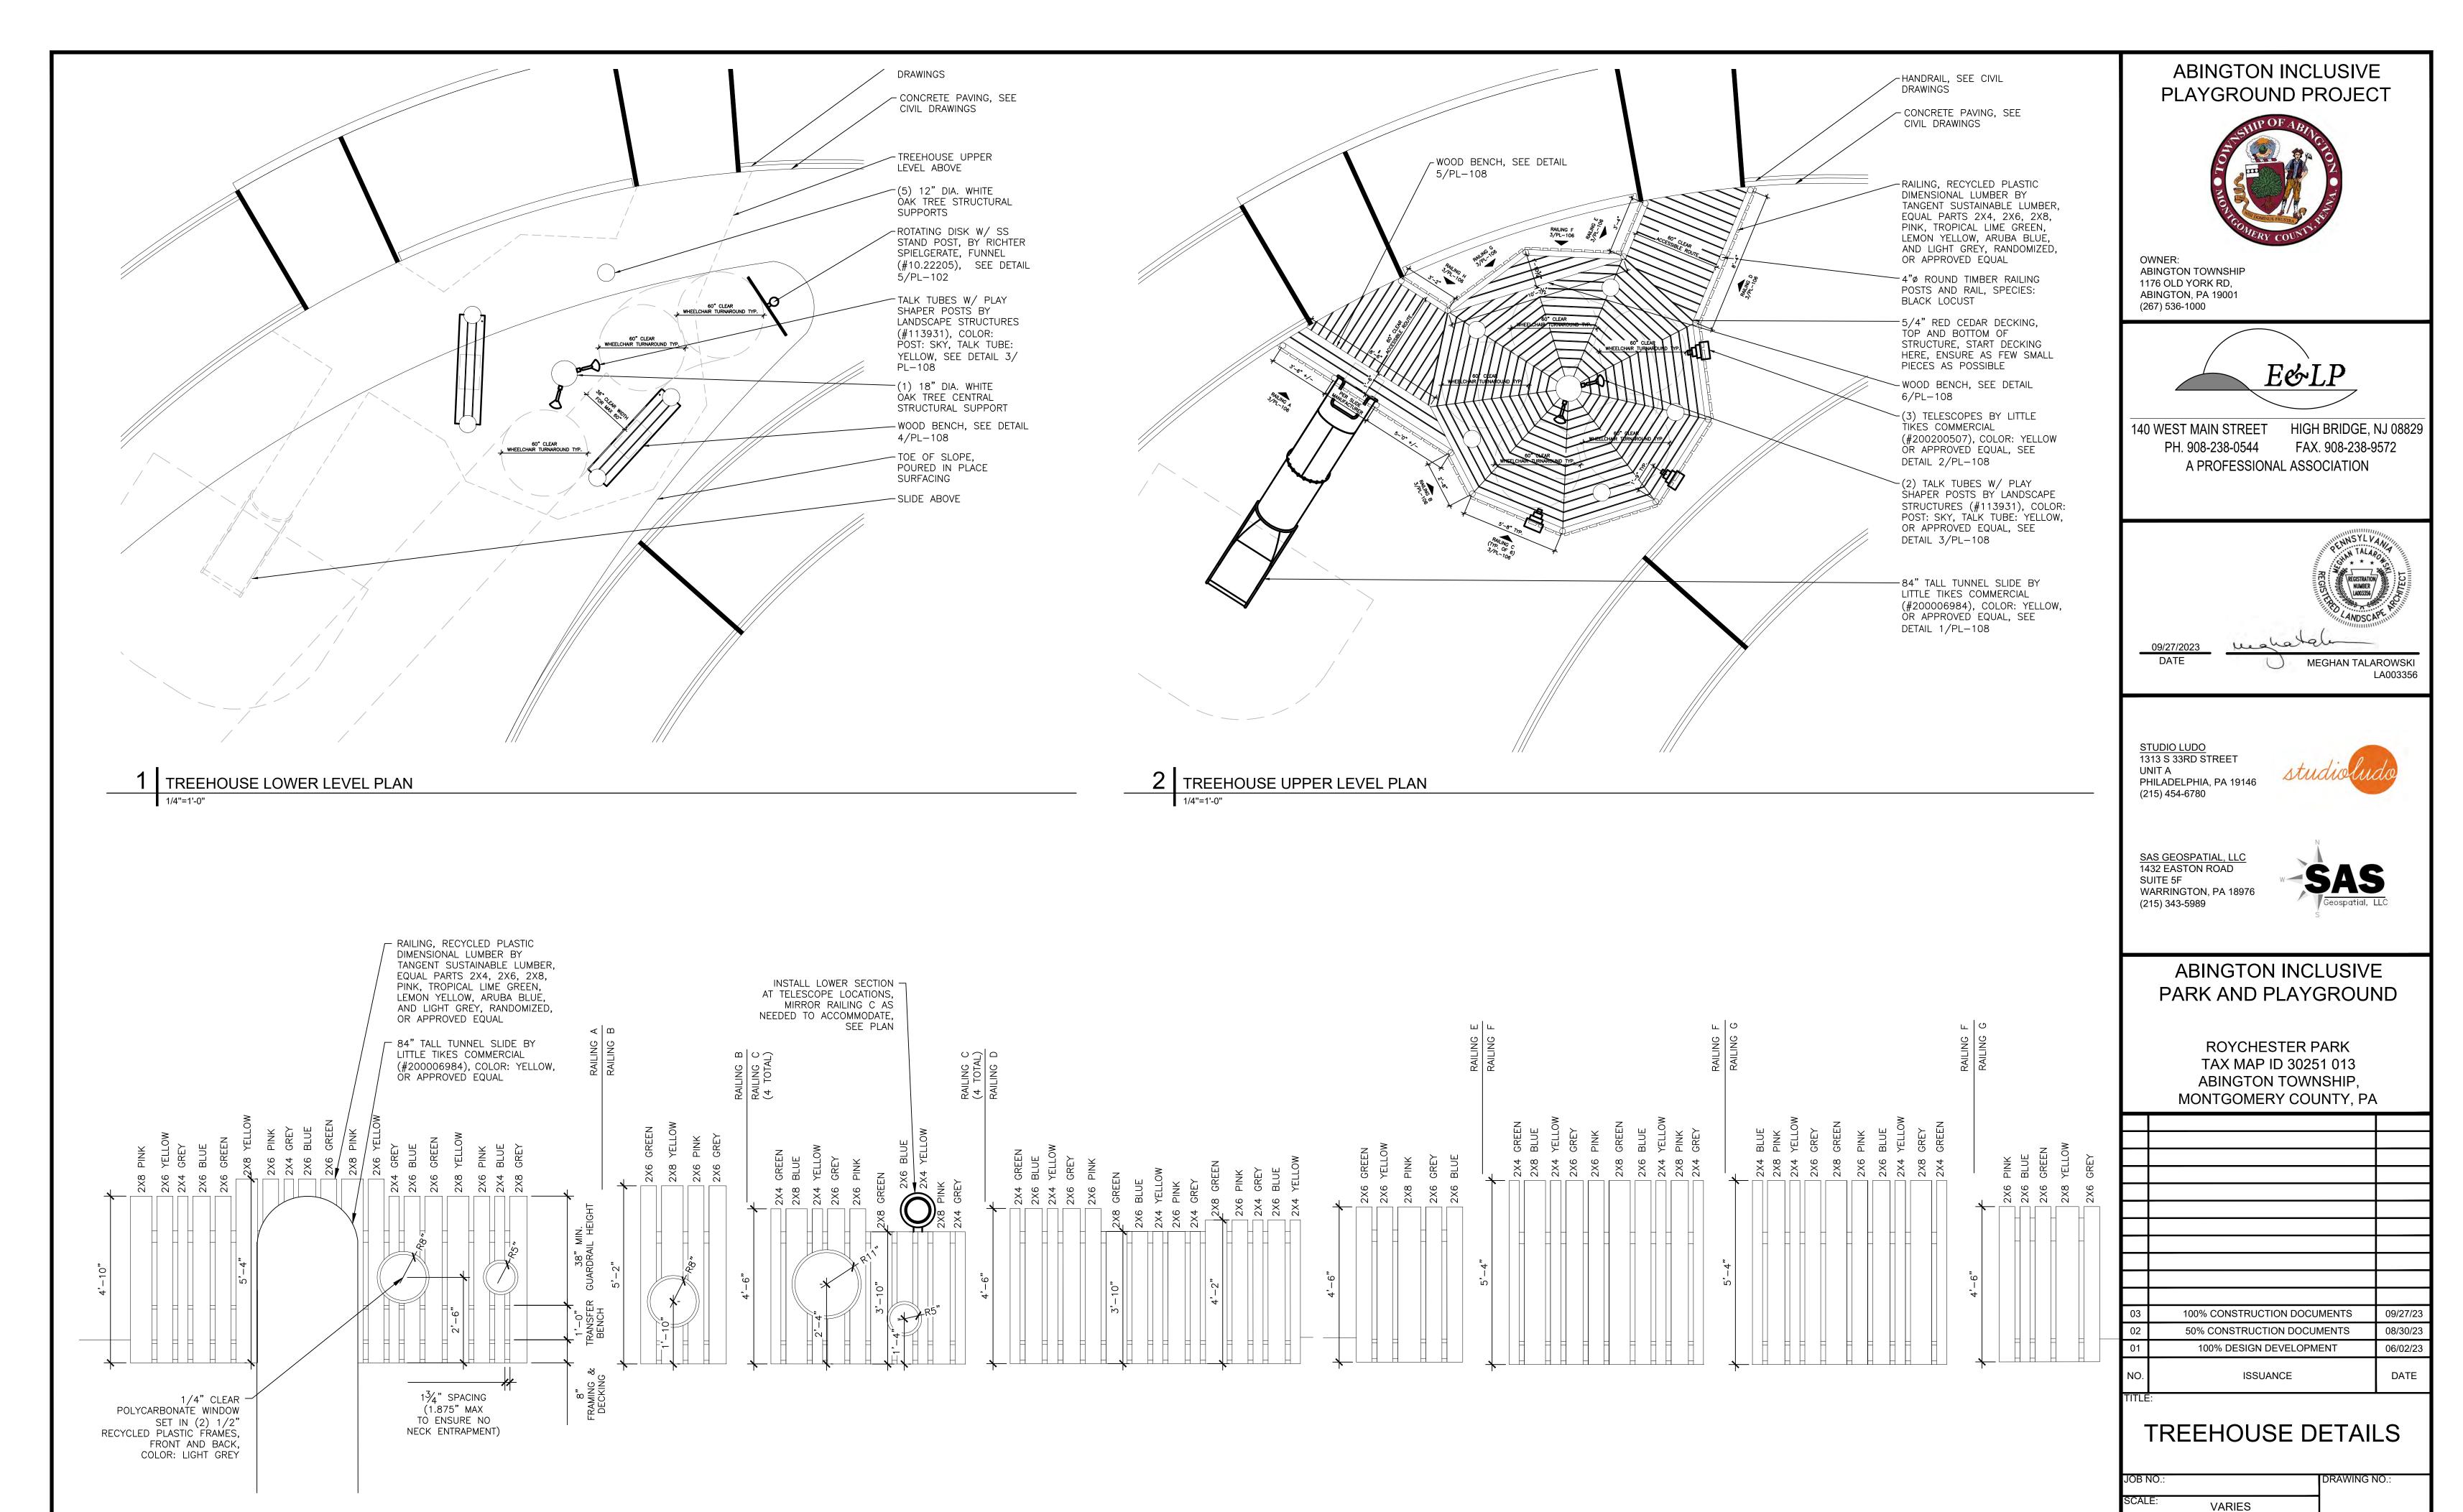
ROYCHESTER PARK TAX MAP ID 30251 013 ABINGTON TOWNSHIP, MONTGOMERY COUNTY, PA

03	100% CONSTRUCTION DOCUMENTS	09/27/23
02	50% CONSTRUCTION DOCUMENTS	08/30/23
01	100% DESIGN DEVELOPMENT	06/02/23
10.	ISSUANCE	DATE
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TREEHOUSE DETAILS

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SCALE:	1/2" = 1'-0"		1
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CHECKED:	MT]PL-
FILENAME:	ABINGTON_SHEETS	S.DWG	

09/27/23



3 TREEHOUSE RAILING DETAILS


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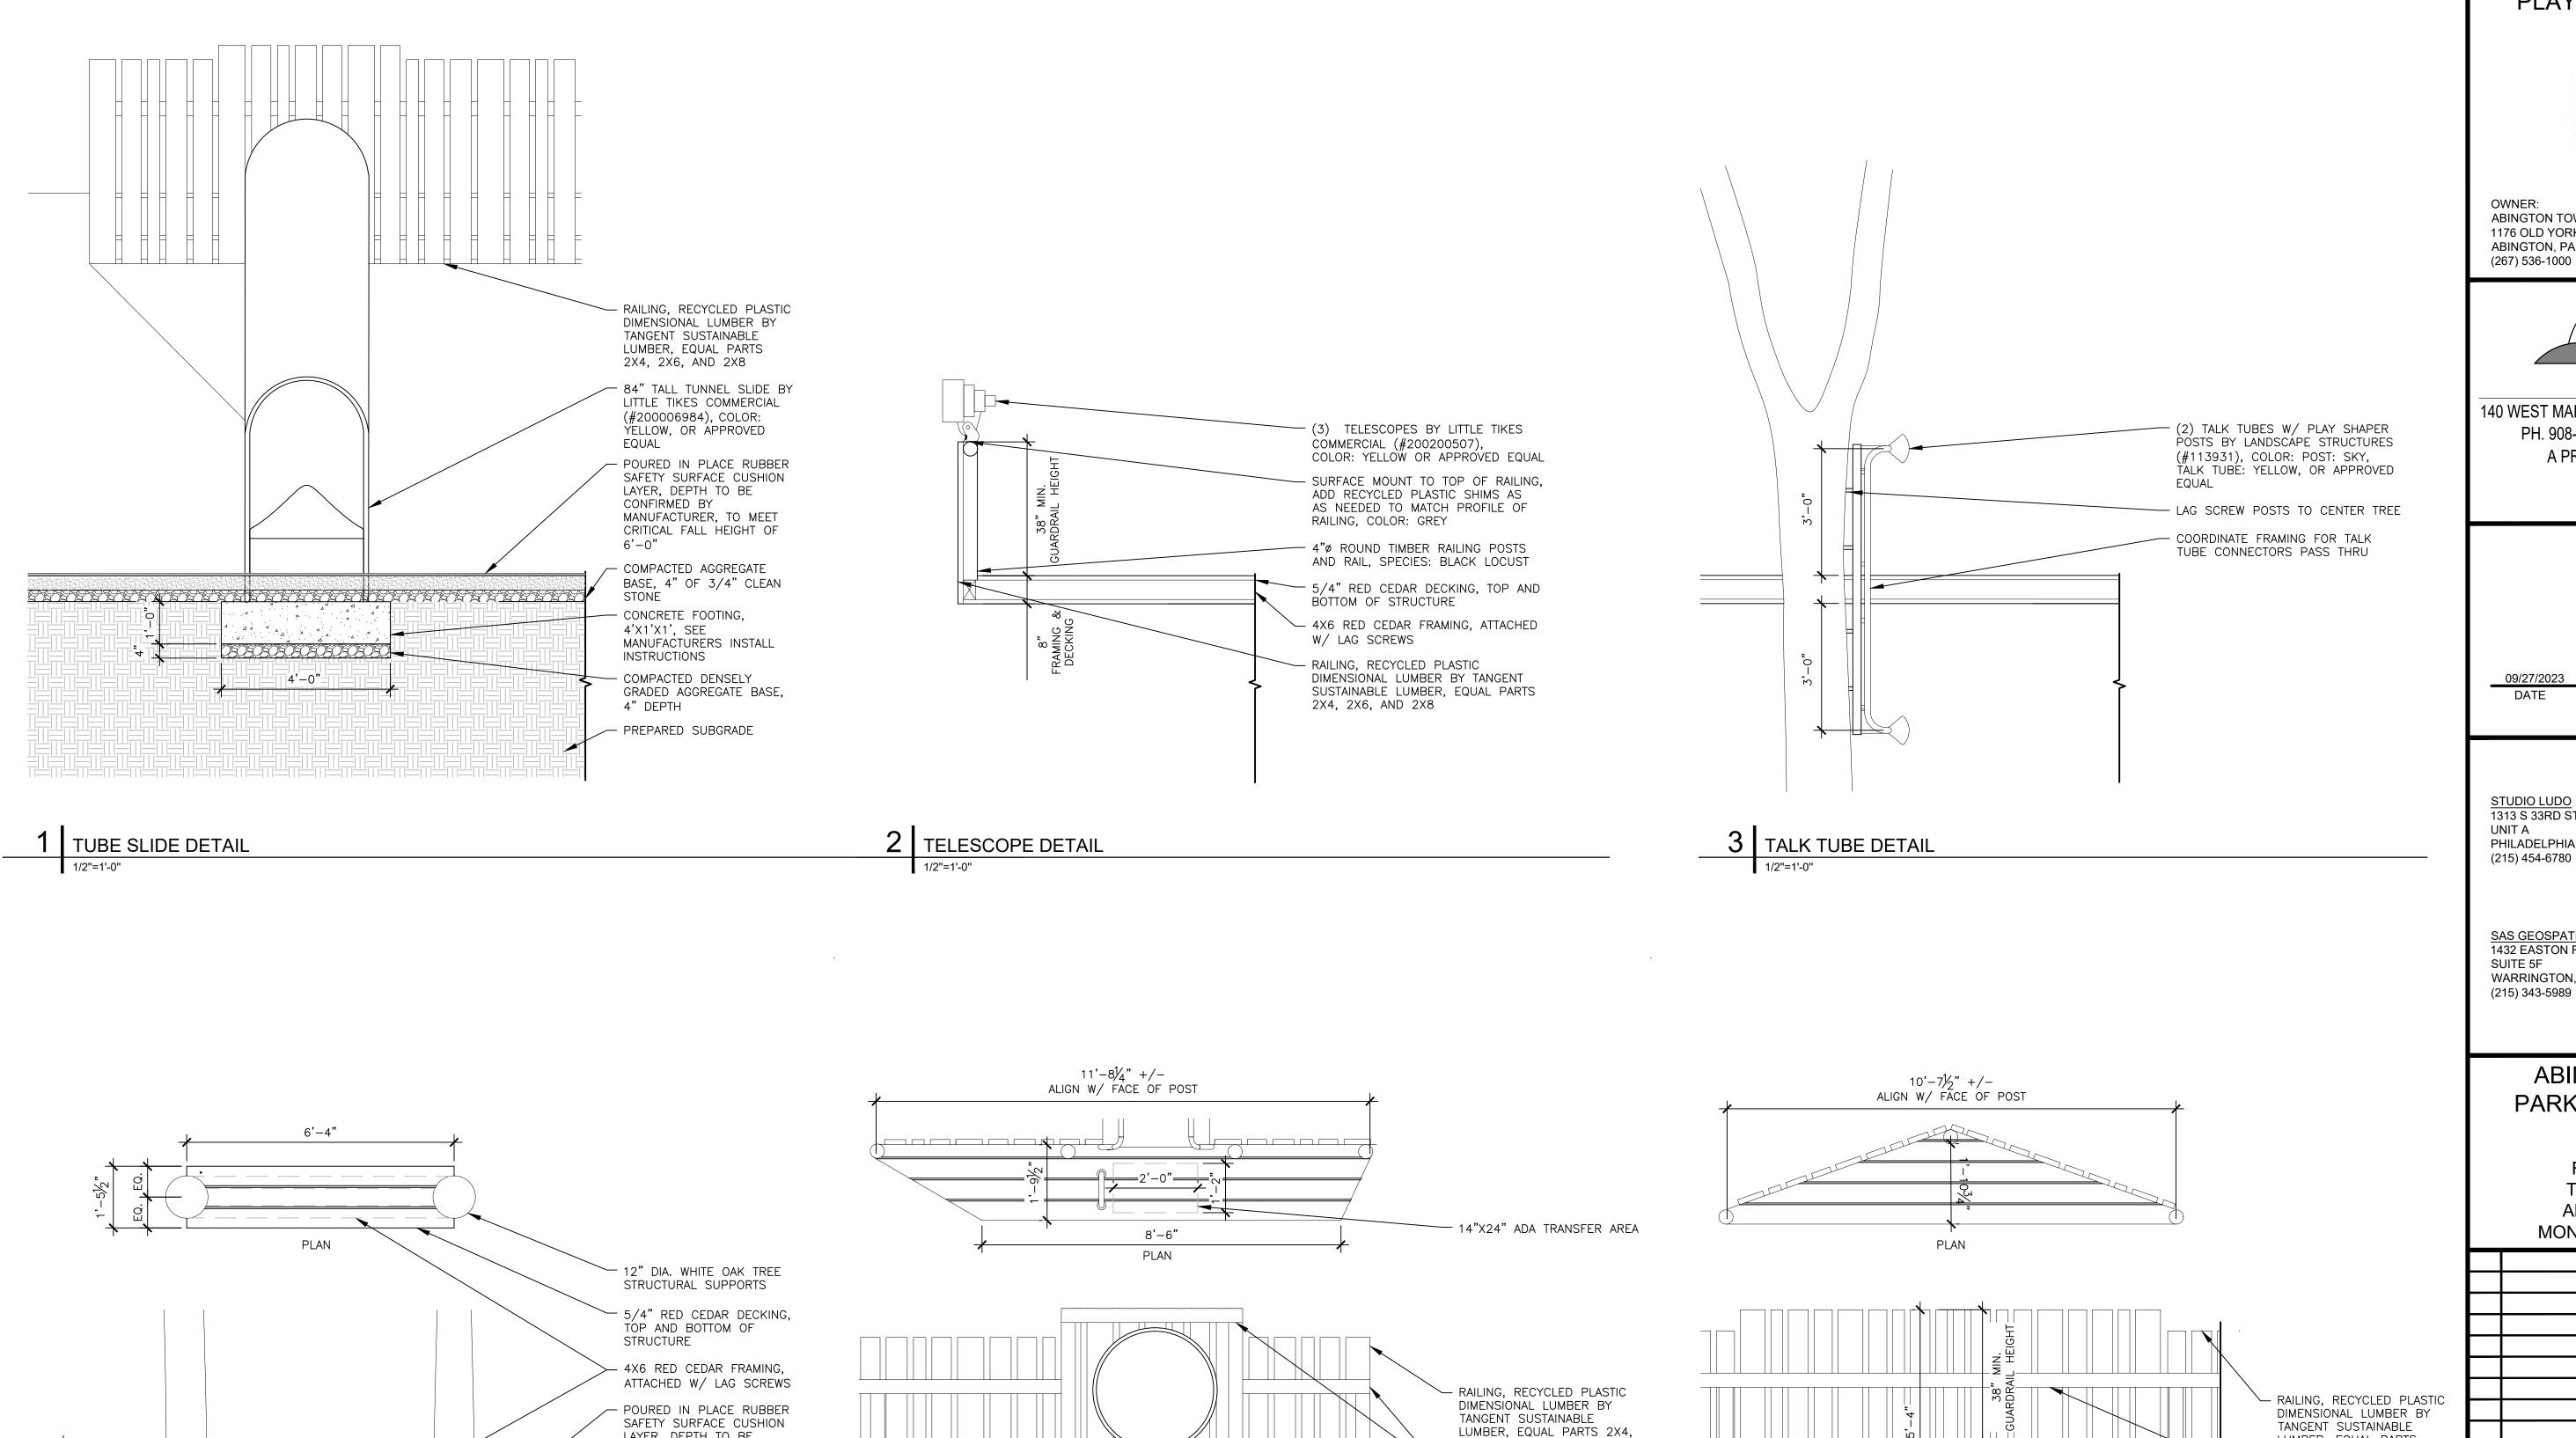
09/27/23

FILENAME: ABINGTON_SHEETS.DWG

CHECKED:

PL-106



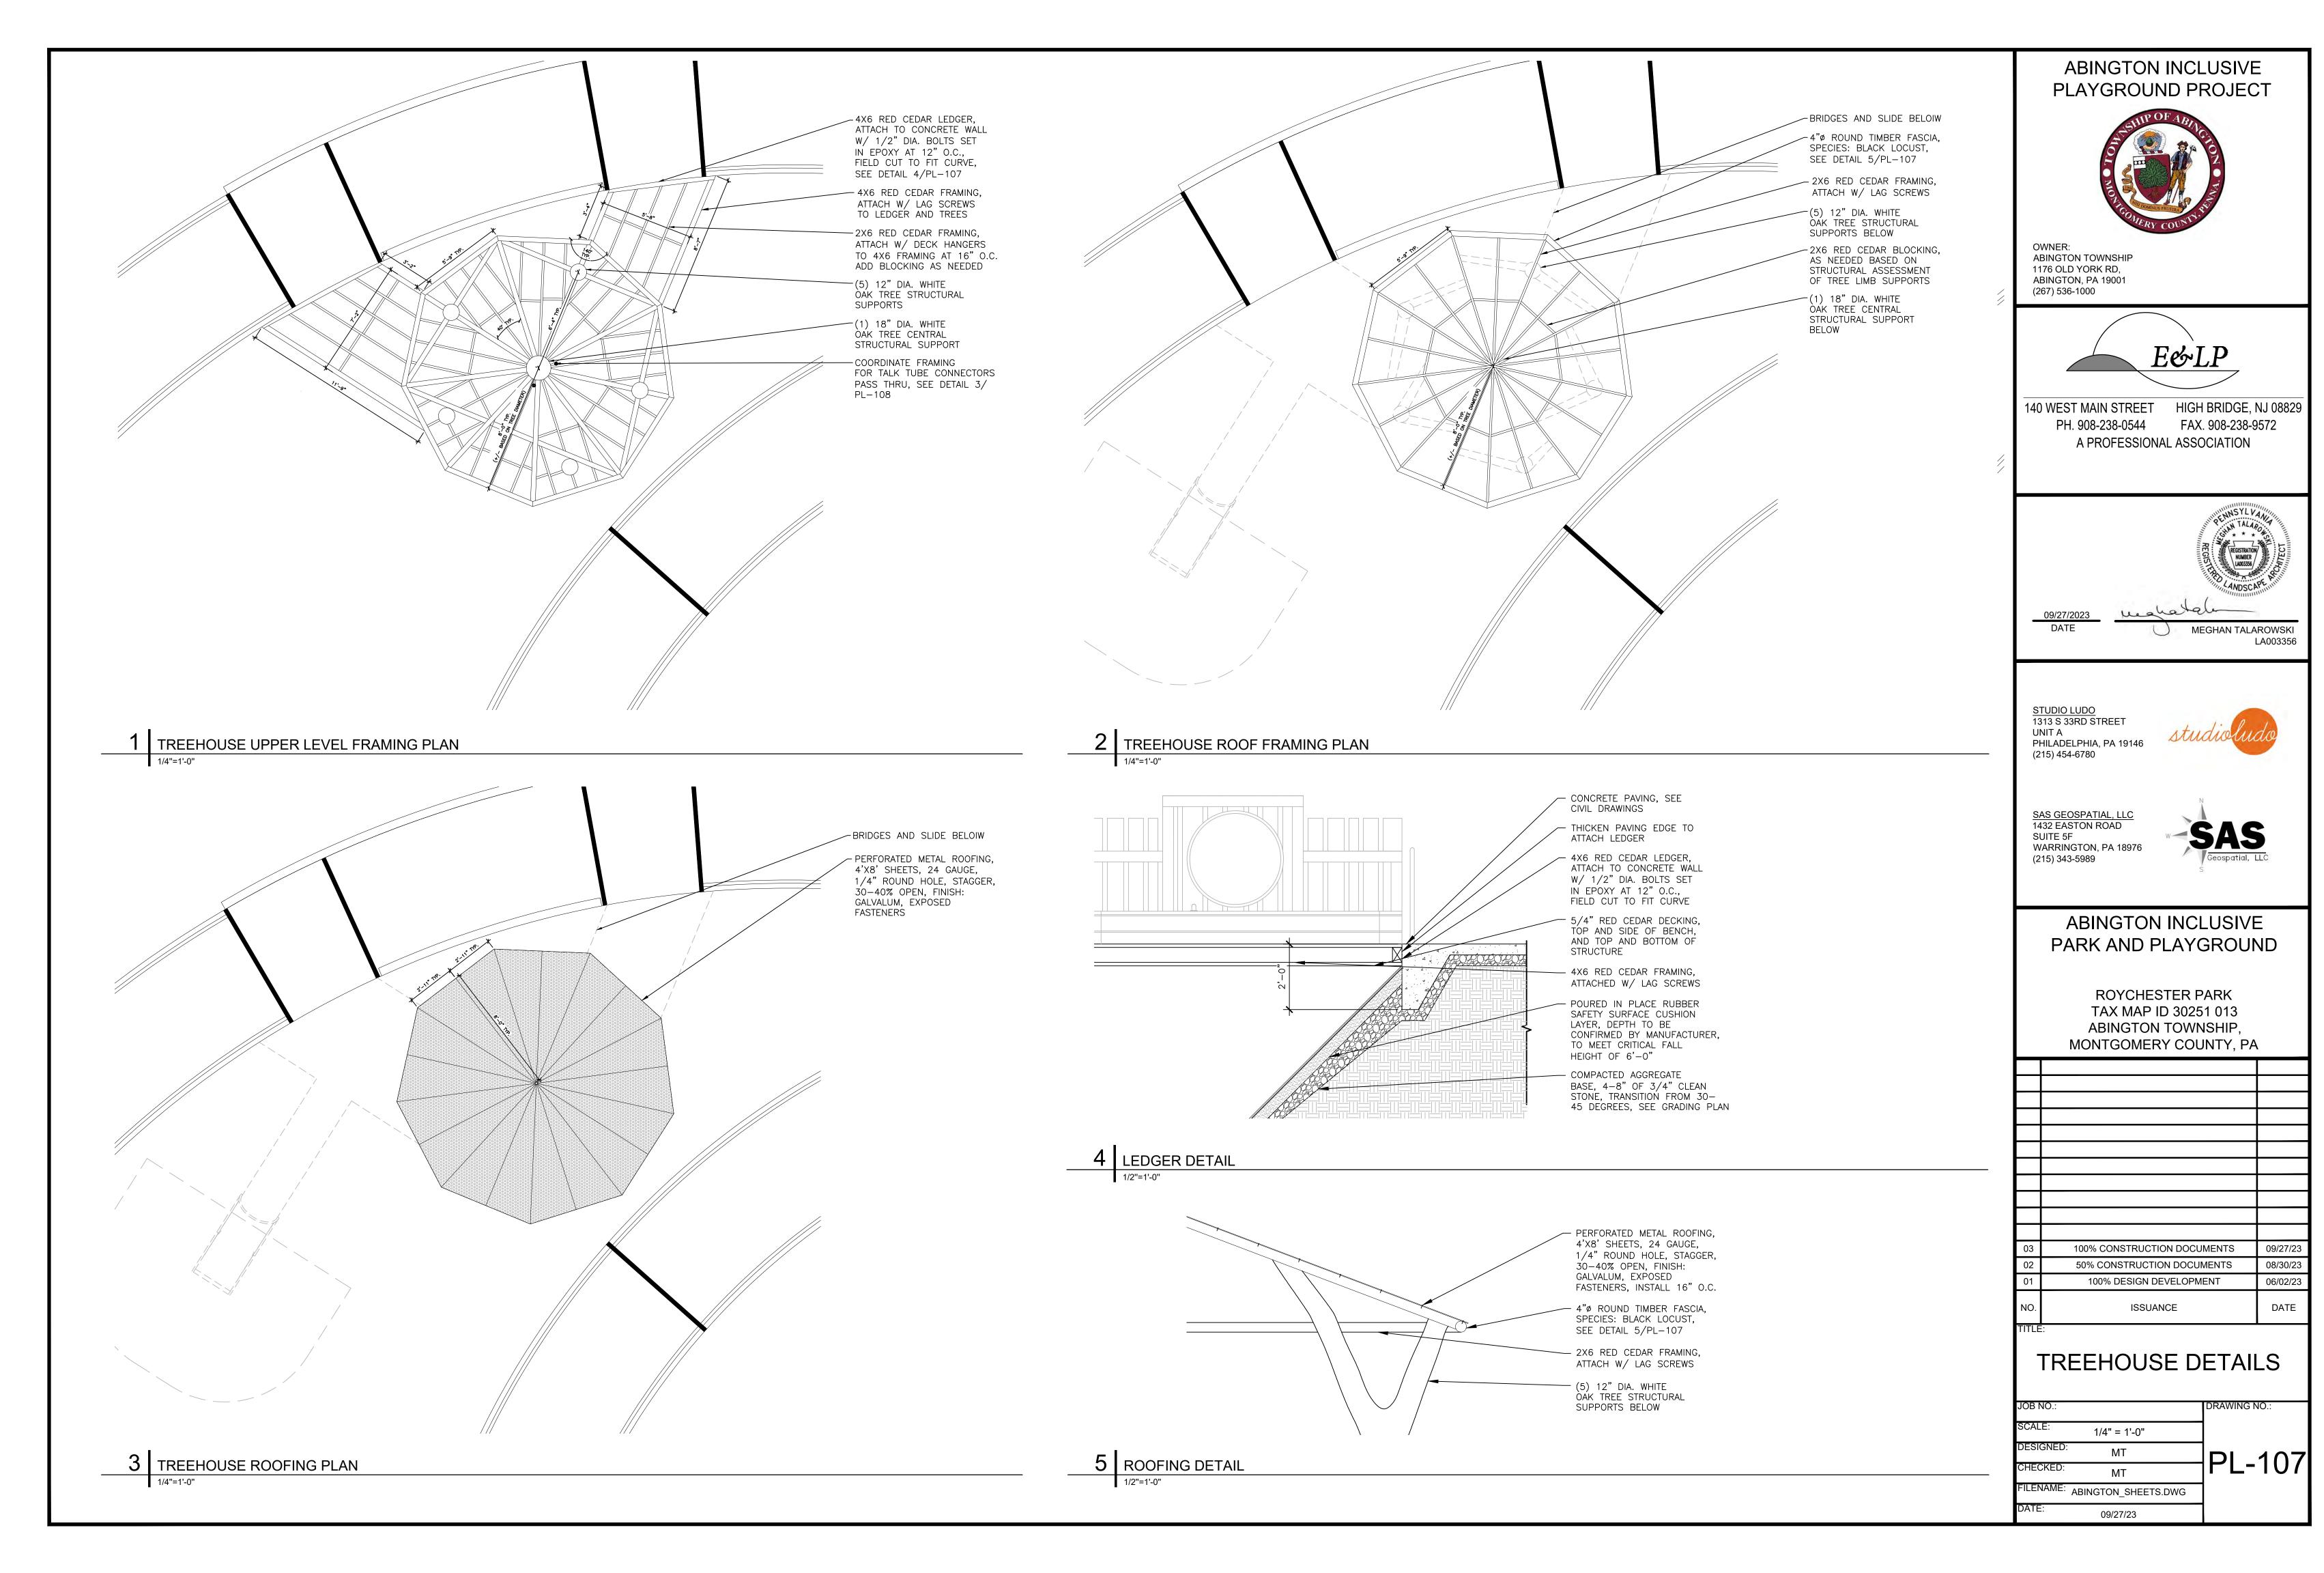

UPPER LEVEL TRANSFER BENCH DETAIL

2X6, AND 2X8

BLACK LOCUST

STRUCTURE

- 4"ø ROUND TIMBER RAILING

POSTS AND RAIL, SPECIES:

- 5/4" RED CEDAR DECKING,

TOP AND SIDE OF BENCH,

AND TOP AND BOTTOM OF

- 4X6 RED CEDAR FRAMING,

ATTACHED W/ LAG SCREWS

- 84" TALL TUNNEL SLIDE BY

(#200006984), COLOR: YELLOW,

6 UPPER LEVEL INTERIOR BENCH DETAIL

LITTLE TIKES COMMERCIAL

- 12" 1.5" DIA. SS TRANSFER

ÖR APPROVEĎ EQUAL

LAYER, DEPTH TO BE

COMPACTED AGGREGATE

BASE, 4" OF 3/4" CLEAN

MANUFACTURERS INSTALL

GRADED AGGREGATE BASE,

HEIGHT OF 6'-0"

- CONCRETE FOOTING,

- COMPACTED DENSELY

- PREPARED SUBGRADE

4'X4'X2', SEE

INSTRUCTIONS

4" DEPTH

STONE

-(20303030303030303


LOWER LEVEL BENCH DETAIL

CONFIRMED BY MANUFACTURER, TO MEET CRITICAL FALL

ABINGTON INCLUSIVE PLAYGROUND PROJECT



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MEGHAN TALAROWSKI LA003356
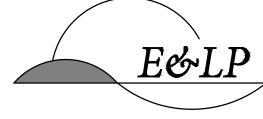
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SAS GEOSPATIAL, LLC 1432 EASTON ROAD SUITE 5F WARRINGTON, PA 18976

LUMBER, EQUAL PARTS

- 4"Ø ROUND TIMBER RAILING

POSTS AND RAIL, SPECIES:

- 5/4" RED CEDAR DECKING, TOP AND SIDE OF BENCH,

AND TOP AND BOTTOM OF

ATTACHED W/ LAG SCREWS

└─ 4X6 RED CEDAR FRAMING,

2X4, 2X6, AND 2X8

BLACK LOCUST

STRUCTURE



ABINGTON INCLUSIVE PARK AND PLAYGROUND

ROYCHESTER PARK TAX MAP ID 30251 013 ABINGTON TOWNSHIP, MONTGOMERY COUNTY, PA

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03	100% CONSTRUCTION DOCUMENTS	09/27/23
02	50% CONSTRUCTION DOCUMENTS	08/30/23
01	100% DESIGN DEVELOPMENT	06/02/23
NO.	ISSUANCE	DATE
TITLE		

TREEHOUSE DETAILS

JOB NO.:		DRAWING NO.:
SCALE:	1/2" = 1'-0"	
DESIGNED:	MT	DI 100
CHECKED:	MT	PL-108
FILENAME:	ABINGTON_SHEETS.DWG	

09/27/23